

KING COUNTY

1200 King County Courthouse 516 Third Avenue Seattle, WA 98104

Signature Report

March 13, 2017

Ordinance 18474

	Proposed No. 2016-0520.2 Sponsors Upthegrove
1	AN ORDINANCE authorizing the county executive to sign
2	a twenty-five year lease enabling the Puget Sound
3	Emergency Radio Network project to occupy and use a
4	portion of the Suquamish Tribe of the Port Madison Indian
5	Reservation's communications site.
6	STATEMENT OF FACTS:
7	1. King County has established a capital improvement project ("the
8	PSERN project") to build the Puget Sound Emergency Radio Network
9	("PSERN").
10	2. King County adopted Proposition 1 and Ordinances 17993, 18074 and
11	18075, to fund the planning, deployment and testing of PSERN.
12	3. King County entered into a contract with Motorola Solutions, Inc., that
13	requires Motorola to identify the sites needed for PSERN's
14	communications equipment together with a list of equipment needed at
15	each site. Motorola identified the Suquamish site of the Suquamish Tribe
16	of the Port Madison Indian Reservation's communications site as one of
17	the needed sites.
18	4. The PSERN project, with the oversight of the county's facilities
19	management division, successfully negotiated a lease with the Suquamish

20	Tribe of the Port Madison Indian Reservation that would enable the
21	PSERN project to use the Suquamish site, located at 22063 Dewberry
22	Road NE, Indianola, Washington, in Kitsap County.
23	BE IT ORDAINED BY THE COUNCIL OF KING COUNTY:
24	SECTION 1. The executive is authorized to execute a lease for the Suquamish
25	site with the Suquamish Tribe of the Port Madison Indian Reservation, substantially in

implement the terms of the lease.

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Ordinance 18474 was introduced on 11/14/2016 and passed by the Metropolitan King County Council on 3/13/2017, by the following vote:

Yes: 9 - Mr. von Reichbauer, Mr. Gossett, Ms. Lambert, Mr. Dunn, Mr. McDermott, Mr. Dembowski, Mr. Upthegrove, Ms. Kohl-Welles and Ms. Balducci

No: 0 Excused: 0

> KING COUNTY COUNCIL KING COUNTY, WASHINGTON

J. Joseph McDermott, Chair

ATTEST:

Melani Pedroza, Acting Clerk of the Council

42 4

Dow Constantine, County Executive

Attachments: A. Lease Agreement dated March 6, 2017

ATTACHMENT A:

LEASE AGREEMENT

SUQUAMISH TRIBE AND KING COUNTY

LEASE AGREEMENT

THIS LEASE AGREEMENT ("Lease") is made and entered into by and between the Suquamish Tribe of the Port Madison Indian Reservation, a federally recognized Indian Tribe organized pursuant to Section 16 of the Indian Reorganization Act of 1934 (25 U.S.C. § 476), hereinafter referred to as the LESSOR or TRIBE, owner of trust lands located within the exterior boundaries of the Port Madison Indian Reservation, acting by and through the Superintendent, Puget Sound Agency, Bureau of Indian Affairs, Department of the Interior, pursuant to the provisions of Federal law, and King County, a political subdivision of the State of Washington, hereinafter referred to as the LESSEE. The Lessor and Lessee may be individually referred to herein as a "Party," and collectively as the "Parties."

1. LEASED FACILITIES.

- A. The Lessor maintains an office address at 18490 Suquamish Way, Suquamish, Washington 98392, and Lessee maintains an office address at 500 Fourth Avenue, Suite 830, Seattle, Washington 98104. Lessor owns and operates the Indianola Forest and Cell Tower Site ("Site"), Allotment 114-T1045, which Site is situated on that certain parcel of real property located at 22063 Dewberry Rd NE, Indianola, WA (Parcel No. 112602-2-007-2000) ("Property"), on the Port Madison Indian Reservation, Kitsap County, State of Washington. The Site and Property are legally described in Exhibit A and depicted in Exhibit B, both attached hereto and incorporated herein by this reference. Lessor hereby leases to Lessee those portions of the Site reasonably necessary for the Lessee to install, operate, and maintain structures, equipment and other property necessary to operate an emergency radio network communication site, to include ingress and egress over the Property (hereinafter designated as the "Leased Premises").
- B. The portion of the Leased Premises leased by Lessor to Lessee shall include those portions of the real property described above, and of an existing tower owned by Lessor on that real property, that are reasonably necessary for Lessee to fulfill its obligations under this Lease, but no more. Lessee's rights to use the real property described above are exclusive as to those portions of the Site used for the installation of certain Communication Facilities (defined in Section 4.A.) as depicted on Exhibit B ("Exclusive Use Area"), but as to the remainder of the Site, including the existing tower on that Property, are not exclusive but are shared with the Tribe and with pre-existing and/or future lessees.
- C. Lessor hereby acknowledges that Lessee plans to fund, procure sites for such emergency radio network communication facilities, and along with other municipalities in King County establish the Puget Sound Emergency Radio Network (the "PSERN System") to eventually provide service in King County as authorized by Proposition 1 and King County Ordinances 17993, 18074 and 18075.

2. TERM.

The "Effective Date" of this Lease is the last date this Lease is approved by the Secretary (defined in Section 19.A.), and signed by the Secretary, Lessor and Lessee. The term of this Lease is twenty-five (25) years, beginning on the first day of the month after the date Lessee commences construction of the Communication Facilities (defined in Section 4.A.) or twenty-four (24) months after the Effective Date of this Lease, whichever is earlier ("Lease Commencement Date") and ending on the twenty-fifth anniversary of the Lease Commencement Date.

3. RENT.

- A. Upon the Lease Commencement Date, Lessee shall pay Lessor \$34,101.12, in advance, as Annual Rent for the first year of this Lease. Upon the first anniversary of the Lease Commencement Date and each anniversary thereafter, the Annual Rent shall increase by 2.25% annually throughout the entire Lease term. See the Lease Rate Schedule attached hereto as Exhibit C and incorporated herein by this reference.
- **B.** Rent for partial lease years shall be prorated and if Rent is ever overpaid it shall be either refunded or applied to future payments at Lessee's discretion. Rent shall be made payable to Lessor and sent to Lessor's address as set forth in Section 35 herein, or as directed by Lessor from time to time.

4. PERMITTED USES.

- A. Lessee shall have the right to use and possess the Site for purposes involving, relating to or supporting telecommunications (the "Permitted Uses"). The term "Permitted Uses" expressly includes, without limitation, the right to install and maintain on the Site communication facilities, including, without limitation, radio and other storage structures and other improvements relating thereto (collectively, "Communication Facilities"). Construction plans for Lessee's Communication Facilities on the Site, which have been reviewed and approved by Lessor, are attached hereto and incorporated herein by this reference in Exhibit D. All Communication Facilities installed by Lessee shall be deemed personal property, and Lessee shall retain title to all such Communication Facilities. Lessee shall comply with all applicable laws in connection with the Permitted Uses and Communication Facilities.
 - **B.** Lessee shall have the right to modify, supplement, replace, upgrade or relocate the Communication Facilities on the Site at any time during the Lease term so long as such activity is consistent with the Permitted Uses and the Lessee receives written consent from the Lessor, which consent shall not be unreasonably withheld, delayed or conditioned. Lessee may erect fences or other barriers to prevent interference with its Communication Facilities.
 - C. Lessee shall have the right to install necessary utilities, including without limitation conduit and sleeving, for its Communication Facilities to the point of connection within

its equipment shelter. Lessee may install a separate electric meter for its electric service on the Leased Premises.

D. Lessee shall have the right to use the existing access road connecting to Dewberry Road for purposes of vehicular and pedestrian access to the Site without Lessor's consent. Lessor shall provide Lessee with access to the Site twenty-four (24) hours per day, seven (7) days per week. Lessor has fenced the exterior of the tower base and will provide Lessee with two (2) keys to the Site. Additional keys will be provided at a cost of \$10 per key.

5. NON-INTERFERENCE.

- A. Lessee shall not use the Site in any way that interferes with the existing use by (i) Lessor or (ii) tenants or licensees of Lessor holding rights to the Lessor's Property on the Effective Date ("Existing Tenants").
- **B.** Lessor warrants to Lessee the use and quiet enjoyment of the Leased Premises. Lessor agrees that it shall not use, or shall it permit its tenants, employees, invitees or agents to use, any portion of the Site or Lessor's Property in any way which would interfere with Lessee's telecommunications operations, provided that continued use by Lessor or Existing Tenants in the same manner as existed as of the Effective Date shall not constitute interference with Lessee's telecommunications operations.
- C. In the event Lessor elects to permit a third party to use any of Lessor's Property for the purpose of installing communication facilities, Lessor shall, thirty (30) days prior to the issuance of such authority, deliver to Lessee engineering studies or other appropriate evidence that such use will not interfere with Lessee's operations at the Site. Should Lessee determine, based on such materials or on its own studies, that the third party will interfere with Lessee's operations, and so notifies Lessor in writing, then Lessor shall not permit the third party to use the Lessor's Property.

6. ENVIRONMENTAL MATTERS.

- A. Lessor represents and warrants to Lessee that Lessor is not aware of any Hazardous Substances located on the Property in soil, groundwater, or other environmental media, or in violation of applicable laws. Lessee and Lessor agree that they will not place, dispose of or store any Hazardous Substances on the Leased Premises or the Property in violation of applicable laws. The Parties acknowledge that, consistent with this Section, Lessee may be installing on the Leased Premises backup power devices such as batteries and generators with petroleum or propane fuel storage tanks.
- **B.** Lessee shall indemnify, defend and hold harmless Lessor with respect to any and all claims, demands, suits, causes of action, judgments, damages, costs, attorney fees, government orders, penalties, or other requirements (hereafter "Claims") arising from the release of any Hazardous Substances on the Leased Premises caused by Lessee, its employees or agents, except to the extent that a Claim is caused by the Lessor, its employees or agents, another tenant, its employees or agents, or a third party.

- C. Lessor shall indemnify, defend and hold harmless Lessee with respect to any and all Claims arising from the presence or release of any Hazardous Substances on the Property, except to the extent that a Claim is caused by Lessee, its employees or agents.
- D. For purposes of this Lease, "Hazardous Substances" shall mean any substance subject to regulation under the Washington Hazardous Waste Management Act (Ch. 70.105 RCW) and implementing regulations, any "hazardous substance" under the Washington Model Toxics Control Act (Ch. 70.105D RCW) and implementing regulations, and any "hazardous substance" or "hazardous waste" as defined by the Comprehensive Environmental Response, Compensation and Liability Act of 1980 (42 USC §§ 9602 et seq.) and implementing regulations, as these laws are amended from time to time; underground storage tanks, whether empty, filled or partially filled with any substance; asbestos; urea formaldehyde foam insulation; PCBs; and any other substance, waste, material or chemical deemed or defined as hazardous, toxic, a pollutant, contaminant, dangerous or potentially dangerous, noxious, flammable, explosive, or radioactive, the removal of which is required or the manufacture, preparation, production, generation, use, maintenance, treatment, storage, transfer, handling, or shipment of which is restricted, prohibited, regulated or penalized by any federal, state, county, municipal or other local governmental statute, regulation, ordinance or resolution as these laws are amended from time to time.
- **E.** The obligations of this Section shall survive the expiration or other termination of this Lease.
- **F.** Prior to commencement of construction of the Communication Facilities on the Site, Lessee shall perform any environmental assessment required for Lessee's Permitted Use by any local, state, tribal or federal authorities.

7. RENEWAL/CANCELLATION/DEFAULT.

- A. This Lease may be renewed for an additional twenty-five (25) year term or for a term of less than twenty-five (25) years by mutual agreement in writing. The consideration for this Lease is subject to adjustment at the time of any such renewal by agreement of the Parties.
- B. This Lease may be terminated by Lessee for any reason or no reason by giving ninety (90) days notice in writing to Lessor, and if the effective termination date is after the Lease Commencement Date Lessee shall pay Lessor an early termination fee equal to three (3) months of the then current Rent on or before the effective termination date. Lessee may also terminate this Lease upon thirty (30) days written notice to Lessor if (i) Lessee determines that it cannot obtain the Government Approvals required to employ the Site for the use described in this Lease, or if any necessary approval is revoked or terminated, or (ii) if Lessee or Lessee's vendor of the PSERN System determines that, for technical, design, interference, environmental, economic or title reasons, the Site is not necessary or suitable for the operation of the PSERN System or the use described in this Lease.

- C. In the event that Lessor elects to no longer use the Property as a communication facility, Lessor shall have the right to terminate this Lease by giving one (1) year prior written notice thereof to Lessee.
- **D.** In accordance with Federal law, the Secretary may terminate this Lease for Lessee's failure to comply with any material term or condition of this Lease or applicable Federal law; *provided*, that this Lease shall not be terminated if: (a) Lessee's failure is cured within thirty (30) days of notice of such failure; or (b) Lessee's failure pertains to a matter other than the payment of any monies due under this Lease, Lessee promptly commences to cure the failure, Lessee diligently pursues such action with continuity to completion, and completion takes place within such reasonable time as may be specified by the Secretary.
- E. If Lessor should fail to remedy any default in the keeping of any term, covenant or condition herein with all reasonable dispatch, within a reasonable period of time no sooner than thirty (30) days after receipt of written notice within which time frame said default has not been cured, then in any of such event(s), Lessee shall have the right, at its option, in addition to and not exclusive of any other remedy Lessee may have by operation of applicable laws, to remedy Lessor's failure to perform or terminate this Lease upon written notice to Lessor.
- F. Subject to Sections 8.B and 28 herein, upon termination or expiration of this Lease, Lessee shall remove its equipment and/or improvements and will restore the Leased Premises to substantially the same condition existing as of the Lease Commencement Date, normal wear and tear and damage beyond Lessee's reasonable control excepted.

8. OWNERSHIP OF PERSONAL PROPERTY PLACED BY LESSEE.

- A. Title to the Communication Facilities, including but not limited to a building or equipment, installed and/or located on the Leased Premises by the Lessee shall vest and remain with the Lessee. Lessor hereby waives any and all lien rights it may have, under any theory of law, statute or otherwise, concerning the Lessee's Communication Facilities or any portion thereof on the Leased Premises. All buildings, tower, equipment or other improvements existing on the Leased Premises prior to the Effective Date of this Lease, or placed by Lessor on the Leased Premises subsequent to the Effective Date of this Lease, shall be and remain the property of the Lessor during the term of this Lease, including any renewal thereof.
- **B**. Lessee shall have the right to remove the Communication Facilities at any time prior to and within sixty (60) days after the expiration or earlier termination of this Lease, subject to Section 28 below; provided, however, upon receipt of Lessor's prior written consent, Lessee may elect not to remove all or any of its improvements from the Property.

9. EXISTING AUTHORIZED USES.

Lessee's rights under this Lease are subject to any prior valid existing right or adverse claim. Lessee's rights under this Lease are subject to existing authorized uses of the Leased Premises (including existing use for the installation, operation and transmission of utility services by the Tribe and/or by third parties authorized by the Tribe, including Tribal utilities, water, sewer, electric, natural gas, television, telephone, fiber optic and data); *provided*, however, such existing authorized uses do not interfere with Lessee's activities that are authorized by this Lease.

10. COMPLIANCE WITH LAW.

Lessee, its employees, agents, and contractors (including subcontractors) shall comply with all applicable Tribal, Federal and State laws when conducting any activity pursuant to this Lease that occurs upon or affects the Leased Premises.

11. UTILITIES.

Lessee shall have the right to obtain all utilities necessary for operation of the Communication Facilities from a servicing utility provider, the installation and maintenance thereof shall be the Lessee's sole obligation, provided that the location of such installation shall be subject to the written consent of the Lessor, which the Lessor will not unreasonably withhold, delay or condition. The Lessee shall pay, as they become due, all bills for electricity and other utilities that are furnished to the Communication Facilities. In the event Lessee cannot secure its own metered electrical supply, Lessee may submeter from Lessor, in which event Lessee will read the submeter on an annual basis and will reimburse Lessor on each anniversary of the Lease Commencement Date for the electricity used by Lessee during the prior lease year.

12. EXISTING UTILITIES.

Lessee will seek to locate all existing utilities prior to, and avoid any damage to existing utilities during, use of the rights granted under this Lease. Lessee will cooperate with utility owners and/or operators to arrange for the prompt repair of any such damage, and shall promptly reimburse the utility owner and/or operator for the cost of such repair.

Lessee shall comply with RCW 19.122 "Underground Utilities" (or any future successor of or replacement for RCW 19.122), in connection with this Lease and any activity it undertakes or utilities it installs pursuant to this Lease. Such compliance shall be in addition to, and not a replacement for or excuse from, compliance with any otherwise applicable existing or future Tribal law or requirement of this Lease.

13. LESSOR'S USE OF PROPERTY.

Lessee shall have exclusive use of the Exclusive Use Area on the Site where the Communication Facilities are installed, provided that Lessee's use of access and utility easements and routes on the Property shall be non-exclusive. Lessor reserves the right to use the Leased Premises for those purposes set out in Section 24 herein below, provided such use is not

inconsistent with the rights herein granted. Lessee agrees not to interfere with the use of the Leased Premises for any purpose not inconsistent with the primary purpose for which this Lease was entered into.

14. WORKMANLIKE MANNER.

Lessee and its employees, agents and contractors (including subcontractors) shall exercise the rights conveyed by this Lease in a workmanlike manner.

15. PERMITS.

Before beginning any activity on the Leased Premises, Lessee, its employees, agents, and contractors (including subcontractors) shall obtain all necessary permits, including all necessary Tribal, Federal or State permits, licenses and approvals ("Government Approvals"), in connection with Lessee's occupancy and use of the Leased Premises, including any survey, construction, operation, inspection, alteration, improvement, maintenance, replacement, or repair activity in the Leased Premises. Lessee, its employees, agents and contractors (including subcontractors) shall comply with any and all conditions of said Government Approvals and shall conform all activity and work to applicable site plans associated with Government Approvals. Lessor hereby authorizes Lessee to make and sign as Lessor's agent any and all applications and/or submissions necessary to obtain all Government Approvals from all applicable governmental and/or regulatory entities required for Lessee's Permitted Use of the Communication Facilities within the Site. Lessor agrees to reasonably assist Lessee with such applications and with obtaining and maintaining the Government Approvals during the term of this Lease.

16. FIRE CONTROL.

Lessee will conduct its activities on and near the Leased Premises so as to reasonably prevent fires on or near the Leased Premises.

17. CULTURAL RESOURCES.

Lessee agrees that during the term of this Lease, if any previously unidentified cultural resources are discovered within the Leased Premises, that any activity that disturbs or threatens to disturb such cultural resources shall be halted immediately and the Tribe shall be contacted immediately.

18. HOLD HARMLESS.

A. Lessee agrees to indemnify and hold Lessor harmless as provided herein to the maximum extent possible under law. Accordingly, Lessee agrees for itself, its successors, and assigns, to defend, indemnify, and hold harmless Lessor, its appointed and elected officials, and employees from and against liability for all Claims, including costs of defense thereof for injury to persons, death, or property damage which is caused by or arises out of Lessee's exercise of rights and privileges granted by this Lease, except to the extent of the Lessor's negligence.

- **B.** Lessor agrees to indemnify and hold Lessee harmless as provided herein to the maximum extent possible under law. Accordingly, the Lessor agrees for itself, its successors, and assigns, to defend, indemnify, and hold harmless Lessee, its appointed and elected officials, and employees from and against liability for all Claims, including costs of defense thereof for injury to persons, death, or property damage which is caused by or arises out of Lessor's exercise of rights and privileges granted by this Lease, except to the extent of the Lessee's negligence.
- C. Where such Claims result from the concurrent negligence of the Parties, the provisions provided in this Section shall be valid and enforceable only to the extent of each Party's negligence.
- **D.** Each of the Parties agrees that its obligations under this Section 18 extend to any Claim brought by, or on behalf of, any of its employees or agents. For this purpose, each of the Parties, by mutual negotiation, hereby waives, with respect to the other Party only, any immunity that would otherwise be available against such Claims under the industrial insurance provisions of Title 51 RCW; provided that such waiver of immunity shall apply only in the event that both Parties carry industrial insurance in compliance with Title 51 RCW.
- **E.** In the event that any of the Parties incurs any judgment, award, and/or cost arising therefrom, including attorney fees, expenses, and costs shall be recoverable from the responsible Party to the extent of that Party's negligence.
- **F.** The provisions of this Section 18 do not apply to Claims that are subject to Section 6.

19. FEDERAL SUPERVISION.

- A. The Tribe has granted the fee simple interest in the Property to the United States of America ("United States"), by and through the Department of the Interior ("DOI"), to hold in trust for the Tribe. In accordance with applicable Federal laws, the Bureau of Indian Affairs ("BIA"), an agency within the DOI, administers and manages on behalf of the DOI tribal lands held in trust by the United States. For purposes of this Lease, the Superintendent of the Puget Sound Agency of the BIA and the Secretary of the DOI, and each of their authorized representatives, are collectively referred to herein as the "Secretary."
- B. As long as any portion of the Leased Premises is held in trust or restricted status by the United States, all of Lessee's obligations under this Lease, and the obligations of its sublessees, assignees and sureties, shall be to the United States as well as to Lessor. Nothing contained in this Lease shall operate to delay or prevent a termination of federal trust responsibilities with respect to the Leased Premises by the issuance of a fee patent or otherwise during the term of the Lease; however, such termination shall not serve to abrogate the Lease. In the event of such termination, all powers, duties or other functions

of the United States or its authorized representative shall terminate, and the responsibilities for enforcing compliance with the covenants of this Lease shall be assumed by the Lessor or successors in interest. The owners of the Leased Premises and the Lessee, its sublessees and assigns and their sureties shall be notified of any such change in the status of the Leased Premises.

- C. No member of Congress or any delegate thereto shall be admitted to any share or part of this Lease or to any benefit that may arise here from.
- **D.** It is understood and agreed that violations of this Lease shall be acted upon in accordance with the regulations in 25 C.F.R. Part 162.
- **E.** It is understood and agreed that this Lease shall be valid and binding only after approval by the Secretary, as evidenced by the Secretary's signature on this Lease below.

20. ASSIGNMENT AND SUBLEASE.

- **A.** Lessee shall not assign or sublet this Lease, in whole or in part, without the prior written consent of the Lessor and the Secretary, which consent shall not be unreasonably withheld, delayed or conditioned.
- **B.** Any sublessee or assignee shall comply with all applicable laws of the Tribe and the United States.
- C. Lessor acknowledges that Lessee and other municipalities participating in the PSERN System intend to establish a new governmental non-profit entity that will eventually own and operate the PSERN System. Notwithstanding anything in this Lease to the contrary, Lessee may assign its interest in this Lease, without the Secretary's or Lessor's consent, to that governmental non-profit entity or to any entity existing now or in the future that will be responsible for the operation, maintenance, management, updating and upgrade or replacement of the PSERN System as authorized by law.
- **D.** In the event of an assignment, the assignee shall assume all liability of the assignor and Lessee will be relieved of all future performance, liabilities and obligations under this Lease to the extent of such assignment.

21 MODIFICATIONS AND AMENDMENTS.

Any modifications or amendments to this Lease must be approved in writing by the Lessor, Lessee and the Secretary.

22. LATE PAYMENT INTEREST.

It is understood and agreed between the Parties hereto that, if any installment of rent is not paid within sixty (60) days after becoming due, interest will be assessed at twelve percent (12%) per annum, from the date due until paid in full.

23. INSURANCE.

- **A.** Lessee maintains a fully funded Self-Insurance program for the protection and handling of the Lessee's liabilities including injuries to persons and damage to property.
- B. Lessor acknowledges, agrees and understands that Lessee is self-funded for all of its liability exposures. Lessee agrees, at its own expense, to maintain, through its fully funded Self-Insurance program, coverage for all of its liability exposures for this Lease. Lessee agrees to provide Lessor with at least thirty (30) days prior written notice of any material change in Lessee's self-funded insurance program and will provide Lessor with a letter of self-insurance as adequate proof of coverage. Lessor further acknowledges, agrees and understands that Lessee does not purchase Commercial General Liability insurance and is a self-insured governmental entity; therefore Lessee does not have the ability to name Lessor as an additional insured.
- C. If Lessor is not a governmental agency which maintains a fully funded Self-Insurance program in accordance with applicable law, Lessor will maintain Commercial General Liability insurance in the amount of One Million Dollars (\$1,000,000) per occurrence and Two Million Dollars (\$2,000,000) general aggregate, based on ISO Form CG 00 01 or equivalent, and will include Lessee as an additional insured with respect to claims arising out of or related to this Lease.
- **D.** Lessor shall carry "All Risk" property insurance in an amount equal to the full replacement value of its improvements on the Property, including Lessor's existing tower.
- E. Lessee shall maintain "All Risk" property insurance in an amount equal to the full replacement value of all its improvements and personal property located on the Leased Premises or shall self-insure improvements and personal property on the Leased Premises.

24. RESERVATIONS.

Lessee shall use the Site exclusively for purposes of communications, except as otherwise agreed to by the Parties in writing. Any rights not expressly provided are reserved by the Lessor, including:

Minerals: The Lessor reserves all rights, as owned by the Lessor, to all mineral rights, including but not limited to oil, gas, or hydrocarbon substances, excluding those brought onto the Property by or at Lessee's direction for its use of the Communication Facilities.

Timber: The Lessor reserves all rights, as owned by the Lessor to timber and forest products on the Leased Premises.

Water: The Lessor reserves all rights, as owned by the Lessor, to water on, under, for the use of or reserved by the United States in connection with the reservation of the Leased Premises.

Easements and Rights of Way: The Lessor reserves the right to establish and utilize such easements, rights of way or service line areas as shall be reasonably necessary from time to time for the provision and installation of public infrastructure including but not limited to conveyances for water, sewer, gas, electrical, cable television, fiber optic, telephone and any other utility benefiting the Lessor.

25. ASSENT NOT WAIVER OF FUTURE BREACH OF COVENANTS.

No assent, express or implied, to any breach of any of the Lessee's covenants, shall be deemed to be a waiver of any succeeding breach of any covenants.

26. VIOLATIONS OF LEASE.

The negotiation and execution of this Lease shall be deemed by the Parties to have occurred within the Port Madison Indian Reservation and Lessee acknowledges that it has voluntarily entered into a consensual contractual relationship with the Tribe. Except for resolution of disputes, as provided in Section 33 herein, it is understood and agreed by the Parties that violations of this Lease shall be acted upon according to the laws of the Suquamish Tribe and, in the absence of any applicable Suquamish Tribal authority, according to the regulations in 25 C.F.R. Part 162 and all other applicable Federal statutory and regulatory provisions. Notwithstanding the forgoing, if there are any discrepancies between the terms of Section 33, Dispute Resolution, and the terms set forth in this Section, the terms of Section 33 shall control.

27. CARE OF PREMISES.

- A. It is understood and agreed that the Lessee is to keep its Communication Facilities and those areas of the Site used exclusively by Lessee in good condition and repair. Lessee shall not commit or permit to be committed any waste whatever on the Leased Premises and shall not remove or tear down any building or other improvements thereto owned by another. Lessee shall not destroy or permit to be destroyed any trees, except with the consent of the Lessor, and shall not permit the Leased Premises to become unsightly. The Lessee will be held financially responsible for all unrepaired damages to improvements or appearance caused by Lessee, except for the usual wear, tear and decay.
- **B.** Lessor shall maintain its tower, the Site and the Property (except for Lessee's Communication Facilities), including access to the Leased Premises from Dewberry Road, in good repair and tenantable condition during the term of this Lease.
- C. Notwithstanding anything in this Lease to the contrary, Lessor shall not maintain, repair or otherwise touch or interfere with Lessee's Communication Facilities without Lessee's prior consent; provided that, in the event of an emergency posing an imminent threat of bodily injury or property damage, Lessor may take action necessary to abate the

threat and shall give Lessee notice of such actions taken as soon as is reasonably possible thereafter.

28 SITE RESTORATION.

The Lessee shall surrender possession of the Leased Premises upon the expiration or termination of this Lease and, if required by the Lessor, shall within sixty (60) days thereafter, or within such additional time as may be mutually agreed upon, return the Leased Premises in as good condition as is possible as that existing at the time of entering upon the same under this Lease, normal wear and tear and damage beyond Lessee's reasonable control excepted; provided that, if the Lessor requires the return of the Leased Premises in such condition, the Lessor shall give written notice thereof to the Lessee at least thirty (30) days before the expiration or termination of the Lease. The restoration of the Leased Premises as aforesaid shall include, but not be limited to, the removal of all debris, concrete slabs and foundations placed by Lessee; the filling of holes and depressions created by Lessee; and grading as required in conjunction with the foregoing. Failing to comply with this stipulation, Lessee agrees to bear all expenses and costs incurred by the Tribe and/or the United States in accomplishing said restoration.

29. INSPECTION OF THE PREMISES.

The Lessor and the Secretary, and their authorized representatives, shall have the rights, at any reasonable times during the term of this Lease, and with reasonable notice, to enter upon the Leased Premises, or any part thereof, to inspect the same and all buildings and other improvements erected and placed thereon.

30 COMPLETE AGREEMENT AND CONSTRUCTION.

- A. This Lease contains the complete statement of the understanding of the Parties with respect to the subject matter of this Lease. There are no other representations, agreements, or understandings, oral or written, by the Parties relating to the subject matter of this Lease that are not fully expressed in this Lease. Each Party acknowledges and represents to the other Party that it is executing this Lease solely in reliance upon its own judgment and knowledge and that it is not executing this Lease based upon the representation or covenant of the other Party, or anyone acting on such Party's behalf, except as expressly stated herein.
- **B.** This Lease has been freely and fairly negotiated by the Parties hereto, each of whom has had the full opportunity to consult legal counsel and to modify the draftsmanship hereof, and, therefore, the terms of this Lease shall be construed and interpreted without any presumption or other rule requiring constructional interpretation against the Party causing the drafting of the Lease.

31. SEVERABILITY.

In the event any term or condition of this Lease or application thereof to any person or circumstance is held invalid, such invalidity shall not affect other terms, conditions, or

applications of this Lease, which can be given effect without the invalid term, condition, or application. To this end, the terms and conditions of this Lease are declared severable; *provided*, however, that this paragraph is not applicable to the following paragraph 32 of this Lease.

32. TRIBAL SOVEREIGNTY.

This Lease shall in no manner diminish, affect or limit any aspect of the Tribe's jurisdiction, dominion or control, whether civil, criminal, regulatory, adjudicatory, licensing, taxation or otherwise, over the Leased Premises, or over anyone or anything thereon or therein, or any activities taking place on, over or under the Leased Premises, without regard to whether the person or entity being regulated is a Tribal member, other Native American or non-Indian person or entity, or State or local governmental authority. This provision is an essential and indivisible part of this Lease; should this provision, at the request of Lessee or its employees, agents, or contractors (including subcontractors), or any person or entity acting in concert with Lessee, be struck down, ruled unenforceable, or ineffective, or in any manner limited, this Lease shall be void and the rights granted by this Lease shall terminate immediately. Nothing whatsoever in this Lease constitutes or shall be construed as a waiver of Tribe's sovereign immunity, except to the extent the Tribe consents to the dispute resolution provisions provided in Section 33 below.

33. DISPUTE RESOLUTION.

- A. <u>Purpose</u>. The Parties intend to resolve their disputes through direct discussion and, if such is not possible, then the Parties consent and will use the dispute resolution framework established in this Section. All stated time frames for resolving disputes may be lengthened by mutual consent.
- B. Direct Discussions. To initiate dispute resolution under this Section, the complaining Party will first submit a written complaint letter to the respective Party's Representative (defined in Section 35) against whom a dispute is lodged, stating therein the nature of the dispute, the requested resolution, and the factual basis supporting the requested resolution. The responding Party will, within ten (10) business days of receiving the complaint letter, provide a written response, stating its agreement or disagreement with the nature of the dispute and the requested resolution. If the responding Party disagrees with the complaint or the proposed resolution, the written response must provide at least one alternate resolution and the factual basis supporting such resolution(s). Thereafter, the Representatives of each Party will, for fifteen (15) business days, make a good faith attempt to resolve the dispute through one or more direct discussions. If no mutually acceptable resolution is reached, the Representatives will prepare a joint statement within five (5) business days, which includes a chronology, a synopsis of the discussions that took place and the last stated positions of each Party.
- C. <u>Mediation</u>. If direct discussions between the Parties fail to resolve the dispute, either Party may, within five (5) business days of completing the direct discussion process, make a written request for mediation to be conducted in Seattle, Washington or at another place as the Parties may agree in writing. If both Parties agree to engage in

mediation, the Parties shall seek a mutually acceptable mediator. If the Parties cannot reach agreement on the selection of the mediator within fifteen (15) business days of the date the written mediation request letter was received by the other Party or Parties, the mediation will be administered by J.A.M.S., Seattle, Washington Office using a J.A.M.S. mediator and protocol, or another mutually agreeable dispute resolution service and protocol. Enforcement of a mediation agreement reached shall be the same as enforcement of an arbitration decision as set forth herein. If a Party objects to proceeding with mediation, then mediation may be bypassed, and the dispute resolved pursuant to arbitration as set forth herein.

- D. Binding Arbitration. Should direct discussions prove unsuccessful in resolving the dispute, and either mediation is not requested, is bypassed, or is also unsuccessful, either the complaining or responding Party may make a written demand for arbitration before a single arbitrator in Poulsbo, Washington or at another place as the Parties may agree in writing. If the Parties cannot reach agreement on the selection of the single arbitrator within fifteen (15) business days of the date the written demand letter was received, the arbitration will be administered by J.A.M.S., Seattle, Washington Office using a J.A.M.S. arbitrator, or another mutually agreeable dispute resolution service. Any arbitrator selected must have a fundamental knowledge of and at least five (5) years' legal experience in contract and construction law and a working knowledge of Indian law. The arbitrator shall have the power to establish a schedule for the hearing, which hearing shall be limited to no more than two (2) consecutive business days to be equally divided between the Parties, including preliminary discovery to the extent the arbitrator deems it necessary and proper under the circumstances, and there shall not be more than two (2) depositions allowed per Party, to make reasonable rules and issue orders necessary for a fair and efficient conduct of the hearing, and to conduct the hearing and administer oaths and affirmations. The arbitrator's decision shall be accompanied by an explanation as to the basis for the award. Washington State contract law shall apply and govern with regard to any dispute over the interpretation of this Lease. Each Party will pay for its own attorneys' fees, and both Parties shall share equally the cost of the arbitrator's fees. All arbitration awards shall be binding upon the Parties and except for a showing of fraud, collusion, or incapacity of the arbitrator, said award cannot be appealed. Relief may include temporary, injunctive or other provisional remedies, along with all other remedies available at law or in equity, except as expressly limited elsewhere in this Lease.
- Enforcement of Arbitration Award. Upon the issuance of an arbitration award or mediation agreement, the prevailing Party may seek the entry of judgment upon the award in any court of competent jurisdiction, which for purposes of Lessee's enforcement against Tribe means the Suquamish Tribal Court and for Tribe's enforcement against Lessee means federal court based upon diversity or other theory of jurisdiction. If federal court jurisdiction is not available, both Lessee and Tribe agree to submit to Kitsap County Superior Court for enforcement of the award against Lessee. The court of competent jurisdiction shall enforce the decision of the arbitrator and shall not modify, correct, alter or vacate said decision in any way, unless the court finds after notice and hearing upon application of a Party to the arbitration, one or more of the following: (1)

the arbitration decision was procured by corruption, fraud or undue means, (2) there was evident of corruption in the arbitrator, or (3) the arbitrator was guilty of the specific misconduct of refusing to hear evidence pertinent and material to the controversy which prejudiced the rights of a Party. No court shall have jurisdiction to interfere in any way with any pending arbitration. No Party may seek from such court any provisional remedy pending appointment of the arbitrator or the arbitrator's rendition of the award. If the court vacates the arbitration decision, then the court shall direct a rehearing either before the same arbitrator or before a new arbitrator to be chosen in the manner provided in this Section.

- F. Limited Waiver of Sovereign Immunity by the Tribe. Except for the limited waiver of sovereign immunity provided in this Section, nothing in this Lease shall be construed as a general or specific waiver of the Tribe's sovereign immunity, which immunities are expressly asserted. The Tribe hereby grants Lessee a limited waiver of sovereign immunity solely for the purpose of dispute resolution as provided in this Section, and such waiver shall not be extended to any other person, agency or entity, except a surety performing under the conditions set out in this Lease ("Limited Waiver"). This Limited Waiver applies only to contractual claims arising out of or under this Lease and does not apply to any non-contractual claims or to claims under any other agreement between the Parties. Furthermore, nothing contained in this Limited Waiver shall be construed to create a contractual relationship with or a cause of action in favor of any third party against the Tribe. This Limited Waiver applies only to the enforcement of a mediation agreement or an arbitration award against the Tribe, provided such mediation agreement or arbitration award has been secured in accordance with the provisions of this Lease.
- G. No Requirement of Exhaustion of Tribal Court Remedies. The Parties acknowledge that under the limited waiver of sovereign immunity provided for herein, the assumption of jurisdiction by any arbitrator or court of competent jurisdiction shall not be delayed or curtailed by any doctrine requiring exhaustion of Tribal court remedies.
- H. No Consent to Washington State Court. The Tribe expressly states and the Lessee understands and acknowledges that the Tribe does not consent to the jurisdiction of the State of Washington or any other state court for any purpose, except if necessary to enforce an award against Lessee as set forth above.
- I. Provisional Remedy Pending Arbitration. The Parties hereby acknowledge and agree that the intent of the PSERN System is to provide dispatch services for first-responders and that any shut-down of Lessee's Communication Facilities, as a result of a dispute between the Parties, would result in a failure of such emergency dispatch services in the geographic area covered by this Site. Therefore, notwithstanding anything to the contrary contained in this Lease, the Parties hereby agree that, so long as no emergency exists that would result in immediate bodily injury or death or sever property damage if the Communication Facilities remains operational, Lessee shall have the right to do all work necessary to maintain and operate the Communication Facilities, unobstructed, at

all times when a dispute is ongoing between the Parties, until the dispute has been resolved and enforced in accordance with the terms of this Section.

34. SUCCESSORS.

This Lease shall be binding upon and inure to the benefit of successors of both Parties.

35. NOTICES AND COMMUNICATIONS.

Lessee shall at all times keep Lessor and the Secretary informed of its address. The Tribe shall at all times keep Lessee informed of its address. Currently, all written notices required under this Lease shall be sent by certified mail, return receipt requested, or reliable overnight courier to the address listed below, and shall be deemed effective upon receipt, refusal or if returned undeliverable:

A. Notice to LESSEE:

King County Facilities Management Division

Real Estate Services

Attention: Leasing Supervisor

Re: Suquamish PSERN Lease

500 Fourth Avenue, Suite 830

Seattle, WA 98104

With Copy To:

King County Facilities Management Division

Director's Office

Attention: Gail Houser

RE: Suquamish PSERN Lease

500 Fourth Avenue, Suite 800

Seattle, WA 98104

With Copy To:

King County Department of Information Technology

Puget Sound Emergency Radio Network

Attention: Marlin Blizinsky

RE: Suquamish PSERN Lease

401 Fifth Avenue, Suite 600

Seattle, WA 98104

B. Notice to LESSOR:

Suguamish Tribe

Attn: Executive Director/Deputy Executive Director

PO Box 498

Suquamish, WA 98392

With a copy to:

Suquamish Tribal Attorney PO Box 498 Suquamish, WA 98392

And, so long as the Leased Premises are held in trust or restricted status, <u>a copy</u> to:

United States Department of the Interior Bureau of Indian Affairs Puget Sound Agency 2707 Colby Avenue, Suite 1101 Everett, WA 98201

Both Parties shall appoint a representative to have responsibility for activities carried out under this Lease and to resolve any disputes that may arise between the Parties ("Representative"), which shall be resolved in accordance with Section 33, Dispute Resolution.

36. DISASTER.

In the event the Leased Premises is destroyed or damaged by fire, earthquake or other casualty so as to render the Site unfit for Lessee's use as provided for herein, Lessee may terminate this Lease and shall be reimbursed for any unearned Rent that has been paid less any utility costs owing. If the Lessee believes it is feasible to relocate the Communication Facilities to a different location on the Property, the Parties agree that the Site and Leased Premises will be relocated. Lessor will provide an interim site for Lessee to locate temporary, mobile Communication Facilities and equipment as necessary to continue service during repair or relocation of the Site and Leased Premises or Communication Facilities. A survey will be prepared for the relocated Site and Leased Premises (including access and utility easements) and the survey will replace Exhibit B attached hereto.

37. REPRESENTATIONS AND WARRANTIES

Lessor represents, warrants and agrees that: (i) the Property is held in trust by the United States, for the benefit of Lessor, and Lessor has the full right, power and authority to grant this Lease to Lessee subject to approval by the Secretary; (ii) the Property is not and will not be encumbered by any liens, restrictions, mortgages, covenants, conditions, easements, leases, or any other agreements of record or not of record, which would adversely affect Lessee's rights under this Lease; and (iii) Lessor's execution and performance of this Lease will not violate any laws, covenants or the provisions of any mortgage, lease or other agreement binding on Lessor.

38. NON-DISCRIMINATION.

Lessee and Lessor, for themselves, their successors, and assigns as a part of the consideration hereof, do hereby covenant and agree to comply with all civil rights and anti-discrimination requirements of federal, state or local laws applicable to the Property, including, without limitation, Chapter 49.60 RCW. Lessee and Lessor shall not discriminate on the basis of race, color, marital status, national origin, religious affiliation, disability, sexual orientation, gender identity or expression or age except by minimum age and retirement provisions, unless based upon a bona fide occupational qualification, in the employment or application for employment or in the administration or delivery of services or any other benefits under King County Code Ch. 12.16.125. Lessee shall comply fully with all applicable federal, state and local laws, ordinances, executive orders and regulations that prohibit such discrimination. These laws include, but are not limited to, Chapter 49.60 RCW, and Titles VI and VII of the Civil Rights Act of 1964. Any violation of this provision shall be considered a default of this Lease and shall be grounds for cancellation, termination, or suspension, in whole or in part, of the Lease and may result in ineligibility for further agreements between the Parties.

39. MISCELLANEOUS.

- **A.** <u>COUNTERPARTS:</u> This Lease may be executed in any number of counterparts, each of which, when so executed and delivered, shall be an original, but such counterparts shall together constitute but one and the same.
- **B.** <u>MEMORANDUM OF LEASE</u>: Lessor agrees to sign a short form Memorandum of Lease that Lessee may record at Lessee's expense.
- C. <u>LIMITATION OF LIABILITY</u>. Except for the indemnity obligations set forth in this Lease, and otherwise notwithstanding anything to the contrary contained in this Lease, Lessee and Tribe each waives any claims that each may have against the other with respect to consequential, incidental or special damages, however caused, based on any theory of liability.

[SIGNATURES ON FOLLOWING PAGE]

IN WITNESS WHEREOF, the Parties hereto have duly executed the Lease. **LESSEE: King County** By: Anthony O. Wright Its: Director, Facilities Management Division Date: STATE OF WASHINGTON) ss. **COUNTY OF KING** _____, 20___, before me personally day of ___ appeared Anthony O. Wright, who acknowledged that he has authority to execute the instrument and acknowledged it as the Director, Facilities Management Division, of King County to be the free and voluntary act of such Party for the uses and purposes mentioned in the instrument. In witness whereof I have hereunto set my hand and affixed my official seal the day and year first above written. Notary Public in and for the State of Washington Residing at My commission expires_____ Approved as to form: **Busch Law Firm PLLC**

LESSOR: Suquamish Tribe of the Port Madison Indian Reservation

By: Leonard Forsman	
Its: Chairman	
Date:	
STATE OF WASHINGTON)) ss.	
COUNTY OF KITSAP)
and acknowledged it as the Chairman of the Reservation to be the free and voluntary at the instrument.	, 20, before me personally edged that he has authority to execute this instrument ne Suquamish Tribe of the Port Madison Indian et of such Party for the uses and purposes mentioned in a set my hand and affixed my official seal the day and
	Notary Public in and for the State of Washington Residing at My commission expires
APPROVED:	
Secretary	Date
	Approved pursuant to 209 DM 8, 230 DM 1,3 IAM 4, 4A

EXHIBIT A Site and Property

Legal Description of the Indianola Forest and Cell Tower Site:

A portion of the Southwest quarter of the Northwest quarter of Section 11, Township 26 North, Range 2 East, W.M., Kitsap County, Washington, described as follows:

Beginning at the Northwest corner of said Section 11;

Thence along the North line of said Section 11, South 88° 27' 12" East 666.36 feet; Thence South 01° 21' 38" West 2037.49 feet to the Southeast corner of the Northwest quarter of said Southwest quarter of the Northwest quarter of Section 11 and the True Point of Beginning;

Thence along the East line of said subdivision, North 01° 21' 38" East 67.11 feet;

Thence South 88° 38' 22" East 136.21 feet;

Thence South 01° 21' 38" West 452.97 feet;

Thence North 88° 38' 22" West 421.39 feet;

Thence North 01° 21' 38" East 383.68 feet to a point on the South line of said Northwest quarter of the Southwest quarter of the Northwest quarter of Section 11;

Thence along said South line South 89° 04' 37" East 285.19 feet to the True Point of Beginning.

Legal Description of the Property:

Parcel I:

The West half of the Northwest quarter of Section 11, Township 26 North, Range 2 East, W.M., in Kitsap County, Washington;

Except the North half thereof;

And except the Northwest quarter of the South half thereof;

Parcel II:

Easements for ingress, egress and utilities over, under and across that certain land described in documents recorded under Recording Nos. 9102250027 and 9202070041, records of Kitsap County, Washington.

APN/Parcel ID: 112602-2-007-2000

EXHIBIT B
(Page 1 of 3)

Depiction of Property, Site and Exclusive Use Area

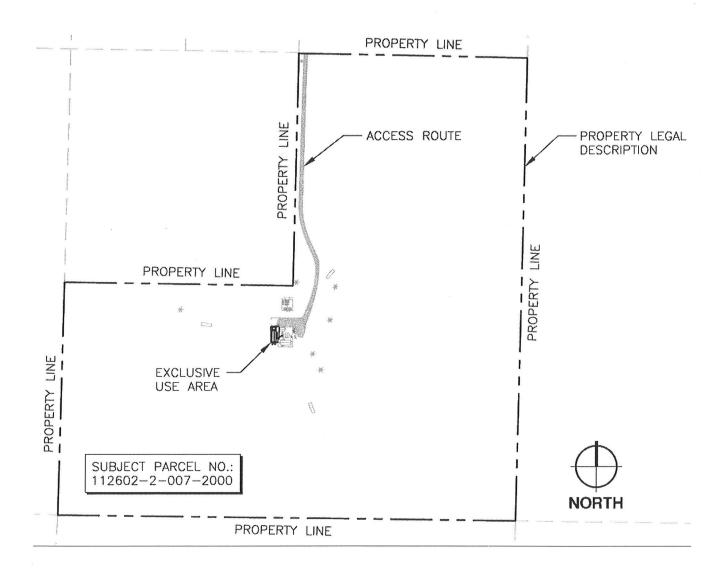


EXHIBIT B (Page 2 of 3)

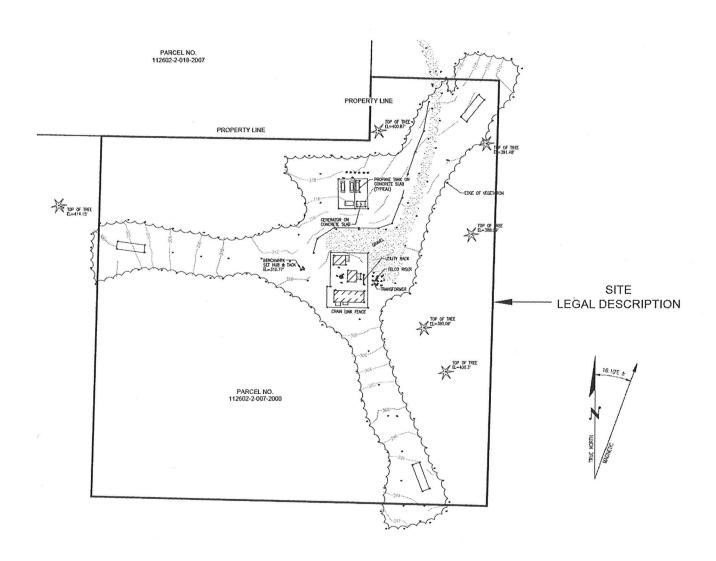


EXHIBIT B (Page 3 of 3)

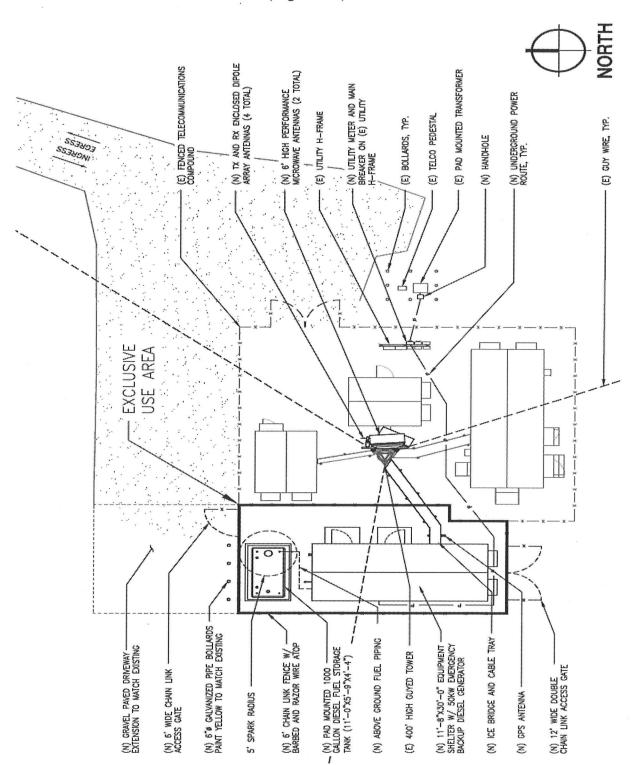


EXHIBIT C

SUQUAMISH TOWER SITE LEASE

RATE SCHEDULE

Description	2017	2018	2019	2020	2021	2022
Space in Building (per sq. ft.)	\$2.24	2.29	2.34	2.39	2.44	2.50
Land Space (per sq.ft.)	\$1.60	1.64	1.68	1.72	1.76	1.80
Up to 200' Antenna Height to						
Ground (per ft.)	0.57	0.58	0.59	0.60	0.61	0.62
Over 200' Antenna Height to						
Ground (per ft.)	0.83	0.85	0.87	0.89	0.91	0.93
Antennas & Sizes						
4' Enclosed Dipole Array	31.84	32.56	33.29	34.04	34.81	35.59
6' High Performance Microwave	38.31	39.17	40.05	40.95	41.87	42.81
8' Enclosed Dipole Array	44.70	45.71	46.74	47.79	48.87	49.97

NOTE: Annual increase at 2.25% each year for each rate.

Rate Card for 2017

	Base			Ht per		
Antenna	Rate	Height	Multiplier	Mo.	Mo. Total	12 mo. Total
Tower Mounted Amplifier	24.98	140'	0.57	79.8	104.78	1257.36
4' Enclosed Dipole Array	31.84	120'	0.57	68.40	100.24	1202.88
4' Enclosed Dipole Array	31.84	120'	0.57	68.40	100.24	1202.88
6' High Performance Microwave	38.31	240'	0.83	239.04	277.35	3328.20
6' High Performance Microwave	38.31	288'	0.83	239.04	277.35	3328.20
8' Enclosed Dipole Array	44.70	140'	0.57	79.80	124.50	1494.00
8' Enclosed Dipole Array	44.70	140'	0.57	79.80	124.50	1494.00
Sub-Total Antenna					1108.96	13307.52
Leased Land Space (1083 sq. ft)	1083'		1.60	e e e e e e e e e e e e e e e e e e e	1732.80	20793.60
2017 TOTAL					\$2,841.76	\$34,101.12

EXHIBIT D

Construction Plans

(attached hereto)

SHEET INDEX ARCHITECTURAL T-1 TITLE SHEET GENERAL NOTES SPECIAL INSPECTIONS CIVIL SURVEY CIVIL SURVEY ADJACENT PARCEL & ZONING ADJACENT PARCEL & ZONING OVERALL EXISTING SITE PLAN ENLARGED PROPOSED SITE PLAN ANTENNA PLAN SOUTH ELEVATIONS NORTH ELEVATIONS A-60 DETAILS A-6.1 A-7 A-8 EQUIPMENT SHELTER PLAN AND ELEVATIONS FUEL TANK DETAIL AND SIGNAGE COVER SHEET AND GENERAL NOTES TEMPORARY EROSION CONTROL PLAN TEMPORARY EROSION CONTROL DETAILS GRADING AND DRAINAGE PLAN STRUCTURAL F1.1 BUILDING AND FUEL TANK FOUNDATIONS STRUCTURAL NOTES F2.1 BUILDING AND TANK FOUNDATION PLANS AND DETAILS

AL

ELECTRICAL ONE LINE DIAGRAM
ELECTRICAL SITE PLAN
GROUNDING PLAN & NOTES
ANTENNA GROUNDING PLANS & NOTES
GROUNDING DETAILS & NOTES WASHINGTON STATE CODE COMPLIANCE

MECHANICAL M1.0 MECHANICAL PLAN

2015 IBC, STANDARDS AND AMENDMENTS, WAC 51-50

2015 IMC. STANDARDS AND AMENDMENTS WAS 51-52 2015 IFC, STANDARDS AND AMENDMENTS, WAC 51-544 2015 UPC, STANDARDS AND AMENDMENTS, WAC 51-56, 51-57 2014 NEC. STANDARDS AND AMENDMENTS, WAC 296-46R 2015 IECC/WASHINGTON STATE ENERGY CODE, WAC 51-11C

PROJECT SUMMARY

PROJECT MANAGERKING COUNTY DEPARTMENT OF
INFORMATION TECHNOLOGY (KCIT)
401 STH AVENUE, STH FLOOR
SEATTLE, WA 98104
CONTACT: HAI PHUNG
PHONE: 206-263-7846
EMAIL: Hol.Phung@KingCounty.gov TECHNICAL LEAD-KING COUNTY DEPARTMENT OF

PERMITING CONTACT:
ODELLA PACIFIC CORPORATION
S506 6TH AVE. S, SUITE 202
SEATILE, WA 98108
CONTACT: BRYSON BURGHARDT
OFFICE: 206-490-3826
MOBILE: 350-581-8189
EMAIL: BBurghardtOdelia.co DEBIGN CONSULTANT:
CAMP + ASSOCIATES, INC.
19401 40TH AVE W, SUITE 304
LYNNWOOD, WA 98035
CONTACT: ERIC CAMP
PHONE: 425—740—6392
EMAIL: ERIC.Comp@CAMPASSOC.co KING COUNTY DEPARTMENT OF INFORMATION TECHNOLODY (KCIT) 401 5TH AVENUE, 6TH FLOOR SEATILE, WA 98104 CONTACT: SEAN DOUGLAS OFFICE: 206-263-8094 MOBILE: 206-550-1656 EMAIL: Sean.Douglas@KingCount

CONSTRUCTION MANAGER-KING COUNTY DEPARTMENT OF INFORMATION TECHNOLOGY (KCIT)
401 5TH AVENUE, 5TH FLOOR
SEATTLE, WA 98104
CONTACT: JOHN A. E. WRIGHT
OFFICE: 206-263-1403
MOBILE: 206-940-0983
EMAIL: John.Wright@KingCounty.go

ALE VENDORODELIA PACIFIC CORPORATION
5506 6TH AVE. S, SUITE 202
SEATTLE, WA 98108
CONTACT: MARK RILEY
PHONE: 425-443-2128
EMAIL: MRIley@Odelia.com

SIGNATURE BLOCK

TITLE

CONSTRUCTION MANAGER

RF ENGINEER

REAL ESTATE

ACQUISITION

PROPERTY

OWNER

TOWER

OWNER

SITE NAME SUQUAMISH

SITE ADDRESS-22063 DEWBERRY RD. NE INDIANOLA, WA 98342 LAND OWNER

UNITED STATES IN TRUST FOR THE SUQUAMISH TRIBE OF INDIANS P.O. BOX 498 SUQUAMISH, WA 98392

JURISDICTION: UNINCORPORATED KITSAP COUNTY PARCEL NUMBER 112602-2-007-2000

PARCEL SIZE 31.23 ACRES ZONING. T (TRIBAL LAND) OCCUPANCY: U (UNOCCUPIED) CONSTRUCTION TYPE-V-B PROJECT AREA 4,290.39 SQ. FT.

NEW IMPERVIOUS SURFACES. 1.688.50 SQ. FT PROJECT DESCRIPTION

(THE SCOPE OF WORK INCLUDES) KING COUNTY PUGET SOUND EMERGENCY RADIO NETWORK (PSERN) CO-LOCATION ON AN EXISTING 400' GUYED TOWER AND ASSOCIATED EQUIPMENT TO PROVIDE EMERGENCY RADIO COMMUNICATIONS TO REACH

PUGET SOUND EMERGENCY RADIO NETWORK


(NEW BUILD)

SUQUAMISH

22063 DEWBERRY RD. NE INDIANOLA, WA 98342

LATITUDE: 47°45'35.17" N (NAD 83) LONGITUDE: 122°31'03.46" W (NAD 83) GROUND ELEVATION: 309.36' (NAVD 88)

CONFIDENTIAL AND PROPRIETARY

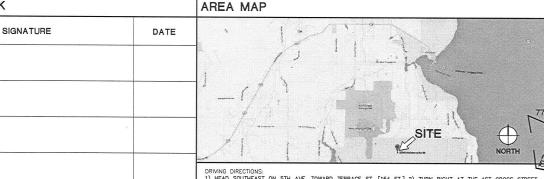

DHINING DIRECTIONS:

1) HEAD SOUTHEAST ON 5TH AVE. TOWARD TERRACE ST. [154 FT.] 2) TURN RIGHT AT THE 1ST CROSS STREET ONTO TERRACE ST. [394 FT.] 3) SUIGHT RIGHT ONTO VESLER WAY [0.3 M.] 4) TURN RIGHT ONTO WESTERN AVE. [443 FT.] 5) TURN LET ONTO COLUMBIA ST. [243 FT.] 6) TURN LET ONTO ALSAKAN WAY S [315 FT.] 7) TURN RIGHT AT THE 1ST CROSS STREET ONTO SEATLE FERRY TERMINAL [489 FT.] 8) CONTINUE STRAIGHT TO STAY ON SEATLE FERRY TERMINAL [0.1 M.] 9) TURN RIGHT [167 FT.] 10) TAKE THE SEATLE — BANBRIDGE SLAND FERRY TO BANBRIDGE ISLAND FERRY TO BANBRIDGE SLAND FERRY TO BA DEWGERRY RD. NE IN INDIANOLA 12) CONTINUE ONTO WA-305 N/OLYMPIC DR. SE [7.3 ML] 13) TURN RIGHT ONTO SUQUAMISH WAY NE [1.6 ML] 14) SUQUAMISH WAY NE TURNS SLIGHTLY LEFT AND BECOMES AUGUSTA AVE. NE [0.8 SOCIAL THAT IS CONTINUE ONTO MILLER BAY RD. NE [2.5 MI.] 16) TURN RIGHT ONTO INDIANOLA RD. NE [0.8 MI.] 17) TURN LEFT AT KINGSTON RD. NE [0.1 MI.] 18) CONTINUE ONTO S KINGSTON RD. NE [0.8 MI.] 19) TURN RIGHT ONTO DEWBERRY RD. NE [0.8 MI.] 19) TURN RIGHT ONTO GRAVEL ROAD AND FOLLOW UNTIL YOU REACH THE SITE.



SUQUAMISH

(NEW BUILD)

22063 DEWBERRY RD. NE





PROJECT MANAGER: EJC

PREPARED BY

APPROVED BY-

06/23/16 ISSUED FOR REVIEW 06/17/16 ISSUED FOR REVIEW 05/26/16 ISSUED FOR REVIEW

PN

05/24/16 ISSUED FOR REVIEW PLAN REVIEWERS SIGNATURE

ARCHECUS SEAMED ARCHITECT WHAUL NIXON

TE OF WASHINGTON

TITLE SHEET

SHEET NUMBER



5506 6TH AVE. S, SUITE 202 SEATTLE, WA 98108 PHONE: (206) 490-3826



CAMP+ ASSOCIATES

9401 40TH AVE. W. SUITE 304

PROJECT MANAGER: FJC

PN

APPROVED BY

08/23/16 ISSUED FOR PERMIT 06/17/16 ISSUED FOR REVIEW

05/26/16 ISSUED FOR REVIEW

PLAN REVIEWERS SIGNATURE

ARCHITECTS TO ROLL ARCHITECT

CONTAUL NIXON STATE OF WASHINGTO

08/23/2016

SHEET NAME

NOTES

SHEET NUMBER

CIVIL NOTES CONTINUALITY MOLES* THE ARCHITECT/SCHOKERS HAVE MADE EVERY EFFORT TO SET FORTH IN THE CONSTRUCTION AND CONTRACT DOCUMENTS THE COMPLETE SOPE OF FORW MINOR CONTRACTORS DOMBON THE 400 ARE INVERTIBLES CUITAMENT THE MINOR CONTRACTORS BOOMS THE 400 ARE INVESTIGATED SUITAMENT THE MINOR CONTRACTOR FROM COMPLETING THE PROJECT AND IMPROVEMENTS IN ACCORDANCE WITH THE MINOR OF THESE DOCUMENTS. THE BIDDET SHALL BEAR THE RESPONSIBILITY OF NOTIFYING (IN WORTHOS) THE SUBJECT OF SHALL BEAR THE RESPONSIBILITY OF NOTIFYING (IN WORTHOS) THE SUBJECTION CONTRACTOR'S PROJECT OF AND THE SUBJECT OF SHALL PRICE THE MORE COSTLY OF DETENDING WIGH, CHARSE SHALL PRICE THE MORE COSTLY OF DETENDING WIGH, CHARSE SHALL PRICE THE MORE COSTLY OF DETENDING WIGH, CHARSE SHACETOR DIFFERENCE OF THE MINOR COSTLY OF DETENDING WIGH, CHARSE SHACETOR DIFFERENCE WIGHTS THE MINOR COSTLY OF DETENDING WIGH, CHARSE SHACETOR DIFFERENCE WIGHT.

- ALL SITE WORK SHALL BE AS INDICATED ON THE DRAWINGS AND STIPULATED IN THE SPECIFICATION PROJECT SUMMARY.
- RUBBISH, STUMPS, DEBRIS, STICKS, STONES AND OTHER REFUSE SHALL BE REMOVED FROM THE SITE AND DISPOSED OF LEGALLY.
- THE SITE SHALL BE GRADED TO CAUSE SURFACE WATER TO FLOW AWAY FROM THE COMMUNICATIONS EQUIPMENT, TOWER AREAS, AND ADJACENT BUILDINGS.
- NO FILL OR EMBANKMENT MATERIAL SHALL BE PLACED ON FROZEN GROUND, FROZEN MATERIALS. SNOW OR ICE SHALL NOT BE PLACED IN ANY FILL OR EMBANKMENT.
- THE SUBGRADE SHALL BE COMPACTED AND BROUGHT TO A SMOOTH UNIFORM GRADE PRIOR TO THE CRUSHED STONE APPLICATION.

SUBGRADE AND BASE PREPARATION-

- FOR SURGED-FORDER CONSTRUCTION BY THE BESCHAPT TO CREDIOMNET THE FOR SURGED-FORDER CONSTRUCTION BY THE SURGED FOR THE SHALL BY THE SHALL FOR THE SHALL FO
- COMPACTION SHALL BE ACCOMPLISHED BY PLACING THE FILL IN SUCCESSIVE, HORIZONTAL, APPROXIMATELY SIX— TO EIGHT—INCH LOOSE LIFTS AND MECHANICALLY COMPACTING EACH LIFT TO AT LEAST THE SPECIFIED MINIMUM DRY DENSITY.
- ANY ORGANIC MATERIAL, DELETERIOUS MATERIAL, OR DISTURBED SOIL SHALL BE REMOVED FROM FLATWORK AREAS.
- THE GROUND SURFACE SURROUNDING EXTERIOR STRUCTURES SHALL BE SLOPED TO DRAIN AWAY IN ALL DIRECTIONS.

CONCRETE NOTES

- ALL CONCRETE WORK SHALL BE IN ACCORDANCE WITH A.C.I. 301, A.C.I. 318 AND THE SPECIFICATION CAST—IN-PLACE CONCRETE.
- UNLESS NOTED OTHERWISE, ALL CAST—IN-PLACE CONCRETE SHALL BE NORMAL WEIGHT, ARR—ENTRANED CONCRETE WITH A MAINIAM COMPRESSIVE STRENGTH OF 3,500 POUNDS FOR SQUARE WORLD AT 28 DAYS. THE HIP PORTION COMENT MILL BE USED WITH A MAINIAM MORECANE SIZE OF 3/4" AND 6% 21% AR ENTRANMENT. ALL CONCRETE WILL MARE A MAINIAM WATER/EXEMPT (M/C) RATO OF 0.46.
- . ALL CONCRETE FLATWORK SHALL HAVE A STIFF BROOM FINISH AND HAVE A SLOPE OF $1/8^{\circ}$ PER FOOT UNLESS NOTED OTHERWISE.
- REINFORCING BARS SHALL BE NEW BILLET STEEL CONFORMING TO A.S.T.M. A615, GRADE 60, DEFORMED.
- DETAIL, FABRICATE AND ERECT REINFORCEMENT BARS, INCLUDING BAR SUPPORTS, SPACERS, ETC. IN ACCORDANCE WITH "DETAILING OF CONC. REINFORCEMENT" (A.C.I. 315-80, REV. 1986).
- UNLESS OTHERWISE NOTED, ALL LAP SPLICES SHALL BE CLASS B CONFORMING TO ACL 318-95.
- A CHAMFER OF 1" SHALL BE PROVIDED AT ALL EXPOSED EDGES OF CONCRETE IN ACCORDANCE WITH A.C.I. 301 SECTION 4.2.4 UNLESS OTHERWISE NOTED.
- CONCRETE WORK SHALL BE COORDINATED WITH THE MECHANICAL EQUIPMENT, AND ELECTRICAL WORK TO ASSURE THAT ALL AFFECTED PIPES, CONDUITS INSERTS, ETC. ARE IN PLACE AND VERHIED BEFORE PLACING CONCRETE.
- CONCRETE COVER FOR REINFORCING BARS SHALL CONFORM TO THE FOLLOWING UNLESS INDICATED OTHERWISE ON THE DRAWINGS:

 -CONCRETE EXPOSED TO WEATHER

 OR IN CONTACT WITH GROUND: 2 INCHES

-CONCRETE CAST AGAINST EARTH: 3 INCHES

COORDINATE LOCATION OF STEEL ANCHOR BOLTS WITH STEEL FABRICATOR PRIOR TO INSTALLATION IN FIELD.

11. CONTRACTOR SHALL PROVIDE SLEEVES FOR ALL WALL/SLAB PENETRATIONS (F CONDUIT, ETC.) POWER, TELCO AND COAX TO ENTER SITE UNDER EQUIPMENT

METAL NOTES

- SECTION INCLUDES: STRUCTURAL STEEL FRAMING MEMBERS, BASE PLATES, PLATES, BARS AND GROUTING UNDER BASE PLATES.
- GROUTING UNDER SEAL FORMS.
 SUBMITTALS:
 SHOP DRAWINGS: INDICATE SIZES, SPACING, AND LOCATIONS OF STRUCTURAL
 VELOCITY OF PENINGS, CONNECTIONS, CAMBERS, LOADS, AND WELDED SECTIONS.
 - QUALITY ASSURANCE TY ASSURANCE
 FABRICATE STRUCTURAL STEEL MEMBERS IN ACCORDANCE WITH AISC
 SPECIFICATIONS FOR THE DESIGN, FABRICATION AND ERECTION OF
 STRUCTURAL STEEL FOR BUILDINGS.

 - PERFORM DESIGN UNDER DIRECT SUPERVISION OF A PROFESSIONAL STRUCTURAL ENGINEER LICENSED IN THE STATE.

PART 2 - PRODUCTS

- STRUCTURAL STEEL MEMBERS: STRUCTURAL TUBING: PIPE: BOLTS, NUTS, AND WASHERS:
 - ASTM A572, GRADE 50 ASTM A500, GRADE B ASTM A53, TYPE E OR S, GRADE B ASTM A325
- ANCHOR BOLTS: WELDING MATERIALS: ASTM A307 AWS D1.1, TYPE REQUIRED FOR MATERIALS BEING WELDED G. GROUT:
 - NON-SHRINK TYPE, PREMIXED COMPOUND CONSISTING OF NONMETALLIC AGGREGATE, CEMENT, WATER REDUCING AND PLASTICIZII ADDITIVES, CAPABLE OF DEVELOPING
- SHOP AND TOUCH-UP PRIMER: SSPC 15, TYPE 1, RED OXIDE TOUCH-UP PRIMER FOR GALV. SURFACES: ZINC RICH TYPE

2. FABRICATION

- CONTINUOUSLY SEAL JOINTED MEMBERS BY CONTINUOUS WELDS. GRIND EXPOSED WELDS SMOOTH.
- 3. FINISH:
- PREPARE STRUCTURAL COMPONENT SURFACES IN ACCORDANCE WITH SSPC SP-1 TO SP-10 PROCEDURES.
- B. STRUCTURAL STEEL MEMBERS SHALL BE HOT DIPPED GALVANIZED.

PART 3 - EXECUTION

- EXAMINATION AND PREPARATION: VERIFY THAT THE FIELD CONDITIONS ARE ACCEPTABLE.

2. ERECTION:

- ALLOW FOR ERECTION LOADS. PROVIDE TEMPORARY BRACING TO MAINTAIN FRAMING IN ALIGNMENT UNTIL COMPLETION OF ERECTION AND INSTALLATION OF PERMANENT BRIDGING AND BRACING.
- FIFLD WELD COMPONENTS INDICATED ON SHOP DRAWINGS.
- DO NOT FIELD CUT OR ALTER STRUCTURAL MEMBERS WITHOUT APPROVAL OF THE ARCHITECT/ENGINEER.
- AFTER ERECTION, TOUCH-UP WELDS, ABRASIONS, AND SURFACES NOT SHOP PRIMED OR GALVANIZED WITH TOUCH-UP PRIMERS AS SPECIFIED UNDER SECTION 05000,—METALS, PART 2 PRODUCTS, H & I. SURFACES TO BE IN CONTACT WITH CONCRETE NOT INCLUDED.
- 3. FIELD QUALITY CONTROL: FIELD INSPECTION OF MEMBERS, CONNECTIONS, WELDS AND TORQUING.

TELECOMMUNICATIONS WIRING COMPONENTS (COAXIAL ANTENNA CABLE)

- GENERAL
- ALL MATERIALS, PRODUCTS OR PROCEDURES INCORPORATED INTO WORK SHALL BE NEW AND OF STANDARD COMMERCIAL QUALITY.
- CERTAIN MATERIALS AND PRODUCTS WILL BE SUPPLIED BY THE OWNER (REFER TO GENERAL CONDITIONS FOR THE LIST OF OWNER FURNISHED EQUIPMENT, MATERIALS AND SUPPLIES FOR THESE TIESS). THE CONTRACTOR IS RESPONSIBLE FOR PICKUP AND DELMERY OF ALL SUCH MATERIALS
- ALL OTHER MATERIALS AND PRODUCTS SPECIFIED IN THE CONTRACT DOCUMENTS SHALL BE SUPPLIED BY THE CONTRACTOR.

2. MATERIALS: A. COAXIAL CABLE:

- IL GOLD.

 INSTALL COMMAL CABLE AND TERMINATIONS BETWEEN ANTENNAS AND EQUIPMENT PER MANUFACTURER'S RECOMMENDATIONS WITH COMMAL CABLES SUPPORTED AT NO MORE THAN 3"-0" O.C. WEATHERPROOF ALL COMMECTORS BETWEEN THE ANTENNA AND EQUIPMENT PER MANUFACTURERS REQUIPMENT. TERMINATE ALL COMMAL CABLE THREE (3) FEET IN EXCESS OF EQUIPMENT LOCATION UNDESS OTHERWISE STATED.
- ALL COAX RUN LENGTHS GREATER THAN 143 FEET SHALL BE 1-5/8" AND IN LENGTH LESS THAN OR EQUAL TO 143 FEET SHALL BE 7/8".
- ANTENNA AND COAXIAL CABLE GROUNDING
 - ALL COAXIAL CABLE GROUNDING KITS ARE TO BE INSTALLED ON STRAIGHT RUNS OF COAXIAL CABLE (NOT WITHIN BENDS)

COAXIAL CABLE IDENTIFICATION

- A. TO PROVIDE EASY IDENTIFICATION AND UNIFORM MARKING OF ANTENNA CABLING, PLASTIC TAGS SHALL BE USED AT THE FOLLOWING LOCATIONS:
 - FIRST LOCATION IS AT THE END OF THE COAX NEAREST THE ANTENNA (WHERE THE COAXIAL CABLE AND JUMPER ARE CONNECTED).

IGNING SHALL PROVIDE AN INDEPENDENT TESTING AGENCY TO PERFORM THE COAXIAL SWEEP TEST & REPORT. THE CONTRACTOR IS TO PROVIDE CLUBER / QUALIFIED PERSONNEL TO ASSIST IN ANY REPAIRS AND WEATHERPROOFING ONCE THE TEST IS COMPLETE. THE CONTRACTOR IS TO PROVIDE OWNER A MINIMIM OF 48 HOURS NOTCE PRIOR TO THE TIME OF THE SWEEP TEST.

CONDUIT USED INDOORS SHALL BE E.M.T., AND RIGID GALVANIZED STEEL FOR OUTDOORS. COUPLINGS SHALL BE RIGID STEEL AND COMPRESSION TYPE FOR E.M.T. SET SCREW FITTINGS ARE NOT PERMITTED. FOR ALL STUBS-UPS. USE RIGID GALVANIZED STEEL

ELECTRICAL NOTES

WIRE AND CABLE SHALL BE OF THE TYPE AND SIZE AS REQUIRED BY NEC. THERE WILL BE NO SPLICES ALLOWED.

PROVIDE HOPE PULLING HAND HOLES AS NEEDED.

CONTRACTOR SHALL PROVIDE TEST OF THE GROUNDING SYSTEM BY CERTIFIED TESTING ACRY. PROVIDE REPORTED TEST RESULTS TO THE PROVIDED REPORT REPORTED THAT FOR ACRY. PROVIDE NO PROVIDED THE STREET REPORT ACRY. PROVIDE NO PROVIDENCE NO PROVI

ALL EXTERIOR GROUND BARS SHALL BE COATED WITH ANTI-CORROSIVE AGENT SUCH AS LPS-3 OR AS PER NOTE 6 ABOVE.

ALL JUNCTION AND OUTLET BOXES TO BE LABELED WITH KROY TAPE, OR EQUAL, DESIGNATING ALL CIRCUIT NUMBERS CONTAINED IN EACH BOX.

CONTRACTOR TO ENSURE ILC PROVIDED WITH (2) INTERNAL TVSS.

CONTRACTOR SHALL COORDINATE WITH SITE SURVEY TO LOCATE EXISTING UNDERGROUND UTILITIES. WHEREVER POTENTIAL CONFLICTS/ INTERFERENCES EXIST, HAND EXCAVATE TO AVOID DAMAGE. CONTRACT ALL UTILITIES TO LOCATE UNDERGROUND PIPING IN PUBLIC

CONTRACTOR SHALL FURNISH AND INSTALL ALL CONDUIT, PULL ROPES, CABLES, PULL BOXES, CONCRETE ENCASEMENT OF CONDUIT (IF REQUIRED), TRENCHING, BACKFILL AND INCLIDE ALL REQUIREMENTS IN SCOPE OF WORK.

GROUNDING NOTES

- . ALL ELECTRICAL WORK SHALL BE PERFORMED IN ACCORDANCE WITH THE DESIGN AND CONSTRUCTION SPECIFICATIONS AND ALL APPLICABLE LOCAL CODES.
- 2. CONDUIT ROUTINGS ARE SCHEMATIC. CONTRACTOR SHALL INSTALL CONDUITS SO THAT ACCESS TO EQUIPMENT IS NOT BLOCKED.
- THE CONTRACTOR IS RESPONSIBLE FOR PROPERLY SEQUENCING GROUNDING AND UNDERGROUND CONDUIT INSTALLATION AS TO PREVENT ANY LOSS OF CONTINUITY IN THE GROUNDING SYSTEM OR DAMAGE TO THE CONDUIT.
- 4. ALL GROUND CONNECTIONS BELOW GRADE SHALL BE EXOTHERMIC (CADWELD).
- ALL GROUND CONNECTIONS ABOVE GRADE (INTERIOR & EXTERIOR) SHALL BE FORMED USING TWO (2) HIGH PRESS CRIMPS.
- ALL EXTERIOR GROUND CONNECTIONS SHALL BE COATED WITH A CORROSION RESISTANT MATERIAL
- ALL EXTERIOR GROUND CONDUCTORS SHALL BE #2 AWG TIN PLATED COPPER UNLESS OTHERWISE INDICATED.
- B. CONNECTIONS TO THE GROUND BUS SHALL NOT BE DOUBLED UP OR STACKED BACK TO BACK CONNECTIONS ON OPPOSITE SIDES OF THE GROUND BUS ARE
- USE OF 90' BENDS IN THE PROTECTION GROUNDING CONDUCTORS SHALL BE AVOIDED WHEN 45' BENDS CAN BE ADEQUATELY SUPPORTED.
- 10. OBSERVE N.E.C. AND LOCAL UTILITY REQUIREMENTS FOR ELECTRICAL SERVICE
- MAXIMUM RESISTANCE OF THE COMPLETED GROUND SYSTEM SHALL NOT EXCEED 5 OHMS.
- 12. CONTRACTOR TO VERIFY CURRENT GROUNDING STANDARDS PRIOR TO CONSTRUCTION.
- 13. ALL GROUNDING SHALL CONFORM TO R56 STANDARDS.

GENERAL NOTES

CONTRACTOR NOTES

DRAWNICS ARE NOT TO BE SCALED, WRITTEN DIMENSIONS TAKE PRECEDENCE, AND THIS SET OF PLANS IS INTENDED TO BE USED FOR DIAGRAMATIC PURPOSES ONLY, UNLESS NOTED OTHERWISE. THE CORPERAL CONTRACTOR'S SCOPE OF WORK SHALL INCLIDE FURNISHING ALL MATERIALS, EQUIPADIT, LABOR, AND ANYTHING ELSE DEVELOR INCESSANT TO COMPLETE INSTALLATIONS AS DESCRIBED HEAVEN.

PRIOR TO THE SUBMISSION OF BIDS, THE CONTRACTORS INVOLVED SHALL VISIT THE USE STATE AND PARTIES THE SECOND WITH ALL CONDITIONS AFFECTING. THE NEW YORK OF THE PROPERTY OF THE PROPERTY OF THE PROCEEDING WITH CONSTRUCTION, ANY ERRORS, OMESSIONS, OR DISCREPANCES ARE TO BE BROUGHT TO THE ACTION OF THE ACRETIC/PROVEREE IN WITH CONSTRUCTION, ANY ERRORS, OMESSIONS, OR DISCREPANCES ARE TO BE BROUGHT TO THE ACRETICATION FOR THE ACRETIC

THE GENERAL CONTRACTOR SHALL RECEIVE WRITTEN AUTHORIZATION TO PROCEED WITH CONSTRUCTION PRIOR TO STARTING WORK ON ANY ITEM NOT CLEARLY DEFINED BY THE CONSTRUCTION DRAWNIOS/CONTRACT DOCUMENTS.

THE CONTRACTOR SHALL SUPERVISE AND DIRECT THE PROJECT DESCRIBED HEREN. THE CONTRACTOR SHALL BE SOLELY RESPONSIBLE FOR ALL CONSTRUCTION MEANS, METHODS, TECHNIQUES, SAUD PROCEDURES AND FOR COORDINATING ALL PORTIONS OF THE WORK UNDER THE CONTRACT.

THE CONTRACTOR SHALL INSTALL ALL EQUIPMENT AND MATERIALS ACCORDING TO MANUFACTURER'S/ VENDOR'S SPECIFICATIONS UNLESS NOTED OTHERWISE OR WHERE LOCAL CODES OR ORDINANCES TAKE PRECEDENCE.

ALL WORK PERFORMED ON PROJECT AND MATERIALS INSTALLED SHALL BE IN STRICT ACCORDANCE WITH JAL APPLICABLE CODES, REQULATIONS, AND ORDINANCES. REQULATIONS, AND ORDINANCES. REQULATIONS AND LAWLIQ ORDERS OF ANY PUBLIC AUTHORITY, MUNICIPAL AND UTILITY COMPANY SPECIFICATIONS, AND LOCAL AND STATE JURISDICTIONAL CODES BEARING ON THE PERFORMANCE OF THE WORK.

THE STRUCTURAL COMPONENTS OF THIS PROJECT SITE/FACILITY ARE NOT TO BE ALTERED BY THIS CONSTRUCTION PROJECT UNLESS NOTED OTHERWISE.

ANTENNA SUPPORTING TOWER IS EXISTING. THE CONTRACTOR SHALL ASSIST ANTENNA INSTALLATION SUB-CONTRACTOR IN TERMS OF COORDINATION AND SITE ACCESS.

GENERAL CONTRACTOR SHALL PROVIDE AT THE PROJECT SITE A FULL SET OF CONSTRUCTION DOCUMENTS UPDATED WITH THE LATEST REVISIONS AND ADDENDA OR CLARIFICATIONS FOR THE USE BY ALL PERSONNEL INVOLVED WITH THE PROJECT.

DETAILS INCLUDED HEREIN ARE INTENDED TO SHOW END RESULT OF DESIGN. MINOR MODIFICATIONS MAY BE REQUIRED TO SUIT JOB CONDITIONS OR SITUATIONS, AND SUCH MODIFICATIONS SHALL BE INCLUDED AS PART OF THE SCOPE OF WORK.

THE CONTRACTOR SHALL MAKE NECESSARY PROVISIONS TO PROTECT EXISTING IMPROVEMENTS, EASEMENTS, PAYING, CURBING, ETC. DURING CONSTRUCTION UPON COMPLETION OF WORK CONTRACTOR SHALL REPIRE ANY DAMAGE THAT MAY HAVE OCCURRED DUE TO CONSTRUCTION ON OR ABOUT THE PROPERTY.

CONTRACTOR SHALL ENSURE THE GENERAL WORK AREA IS KEPT CLEAN AND HAZARD FREE DIBRING CONSTRUCTION AND DISPOSE OF ALL DIRT, DEBRIS, RUBBISH AND REMOVE EQUIPMENT NOT SPECIFIED AS REMAINING ON THE PROPERTY. PREJUISES SHALL BE LET IN CLEAN CONDITION AND FREE FROM PAINT SPOTS, DUST, OR SAUDICES OF ANY MAUTIER.

THE CONTRACTOR SHALL COMPLY WITH ALL LOCAL AND NATIONAL CODES, REGULATIONS, AND SAFETY REGULATIONS, ALL OSHA REGULATIONS, ALL PUBLIC AND MUNICIPAL AUTHORITIES, AND ANY UTILITY COMPANIES' REGULATIONS AND DIRECTIVES.

THE BRAWNOS AND SPECIFICATIONS ARE A GENERAL INJECTIVES.

THE BRAWNOS AND SPECIFICATIONS ARE A GENERAL INJECTIVE OR THE FEEL THE SOURCE OF UNCOUNTED THE SOURCE OF UNITED THE SOURCE OF UN

CONTRACTOR IS RESPONSIBLE FOR FIELD MEASUREMENTS TO CONFIRM LENGTHS OF CABLE TRAYS AND ELECTRICAL LINES AND ANTENNA MOUNTING.

VERIFICATION THAT EXISTING TOWER/POLE/STRUCTURE CAN SUPPORT THE PROPOSED ANTENNA, COAX & ADDITIONAL EQUIPMENT LOADING IS TO BE DONE BY OTHERS.

TESTING

 SECOND LOCATION IS INSIDE THE EQUIPMENT SHELTER NEAR THE WAVEGUIDE ENTRY PORT. R. LISE ANDREW CARLE TIES (PT # 27290) TO SECURE IDENTIFICATION TAGS

GENERAL

SP-1



5506 6TH AVE, S, SUITE 202 SEATTLE, WA 98108 PHONE: (206) 490-3826 WWW.ODELIA.COM



19401 40TH AVE. W, SUITE 304 LYNNWOOD, WA 98036 PHONE: (425) 740-6392 FAX: (425) 252-2860

PROJECT MANAGER: EJC

LM

PREPARED BY

APPROVED BY-

IPPROV	PN	
08/23/16	ISSUED FOR	PERMIT
06/23/16	ISSUED FOR	REVIEW
06/17/16	ISSUED FOR	REVIEW
05/26/16	ISSUED FOR	REVIEW
05/24/16	ISSUED FOR	REVIEW

PLAN REVIEWERS SIGNATURE

ARCHITECT
ARCHIT

SHEET NAME

SPECIAL INSPECTIONS

SHEET NUMBER SP-2

STEEL SPECIAL INSPECTIONS		
AISC 360 - TABLE NS.6-1 INSPECTION TASKS PRIOR TO BOLTING		
INSPECTION TASKS PRIOR TO BOLTING	QC	QA
MANUFACTURER'S CERTIFICATIONS AVAILABLE FOR FASTENER MATERIALS	0	0
FASTENERS MARKED IN ACCORDANCE WITH ASTM REQUIREMENTS	0	0
PROPER FASTENERS SELECTED FOR THE JOINT DETAIL (GRADE, TYPE, BOLT LENGTH IF THREADS ARE TO BE EXCLUDED FROM SHEAR PLANE)	0	0
PROPER BOLTING PROCEDURE SELECTED FOR JOINT DETAIL	0	0
CONNECTING ELEMENTS, INCLUDING THE APPROPRIATE FAYING SURFACE CONDITION AND HOLE PREPARATION, IF SPECIFIED, MEET APPLICABLE REQUIREMENTS	0	0
PROPER STORAGE PROVIDED FOR BOLTS, NUTS, WASHERS AND OTHER FASTENER COMPONENTS	0	0

AISC 360 - TABLE N5.6-2 INSPECTION TASKS DURING BOLTING		
INSPECTION TASKS DURING BOLTING	QC	QA
FASTENER ASSEMBLIES, OF SUITABLE CONDITION, PLACED IN ALL HOLES AND WASHERS (IF REQUIRED) ARE POSITIONED AS REQUIRED	0	0
JOINT BROUGHT TO THE SNUG-TIGHT CONDITION PRIOR TO THE PRETENSIONING OPERATION	0	0
FASTENER COMPONENT NOT TURNED BY THE WRENCH PREVENTED FROM ROTATING	0	0
FASTENERS ARE PRETENSIONED IN ACCORDANCE WITH RCSC SPECIFICATION, PROGRESSING SYSTEMATICALLY FROM THE MOST RIGID POINT TOWARD THE FREE EDGES	0	0

AISC 360 - TABLE N5.6-3 INSPECTION TASKS AFTER BOLTING		
INSPECTION TASKS AFTER BOLTING	QC	QA
DOCUMENT ACCEPTANCE OR REJECTION OF BOLTED CONNECTIONS	P	Р

QC = QUALITY CONTROL TASKS TO BE PREFORMED BY STEEL FABRICATOR OR ERECTOR.

OA = QUALITY ASSURANCE TASKS TO BE PREFORMED BY A SPECIAL INSPECTION AGENCY OR INDIVIDUALS DEFINED BY AWS 85.1 OR INDIVIDUALS QUALIFIED UNDER THE PROVISIONS OF AWS D.1.70.1.1M SUBCAUSE 6.1.4.

O = OBSERVE THESE ITEMS ON A RANDOM BASIS. OPERATIONS NEED NOT BE DELAYED PENDING THESE INSPECTIONS.

P = PERFORM THESE TASKS FOR EACH BOLTED CONNECTION.

REQUIRED STRUCTURAL OBSERVATION:

STRUCTURAL OBSERVATION FOR SEISMIC RESISTANCE STRUCTURE HEIGHT > 75' PER IBC 1704.5.1

SPECIAL INSPECTIONS

SPECIAL INSPECTIONS IN ACCIONANCE WITH ISC 110 AND 1704 SHALL BE PERFORMED (AS REQUIRED) BY A OULUFED TESTING ASENCY APPROVED BY THE ARCHITET/DIAMERER. INSPECTION ARCHIT SHALL BE RETINATE BY THE PROJECT OWNER OF THEIR RESPONSIBLE CHARGE. THE ARCHITET, DIAMERER OF RECORD, AND BILLIANS DEPARTMENT SHALL RECOVE COPIES OF ALL INSPECTION AND TEST RESALTS. REFER TO DOCUMENTS FOR SEPCRIC PROMISSION.

TENS TO BE INSPECTED:


1. ANCHOR BOLTS (1/2" # ANCHOR BOLTS PROVED LOAD IS: 1,500 LBS. IN TENSION)

2. HIGH STRENGTH BOLTS (A325 OR EQUINALENT)

TABLE 1705.3 REQUIRED VERIFICATION AND INSPECTION OF CONCRE	TE CONSTRUCTIO	N		
VERIFICATION AND INSPECTION	CONTINUOUS	PERIODIC	REFERENCED STANDARD	BC REFERENC
INSPECTION OF REINFORCING STEEL, INCLUDING PRESTRESSING TENDONS, AND PLACEMENT.	-	×	ACI 318: 3.5, 7.1-7.7	1910.4
2. INSPECTION OF REINFORCING STEEL WELDING IN ACCORDANCE WITH TABLE 1704.3, ITEM 58	-	-	AWS D1.4 ACI 318: 3.5.2	-
3. INSPECTION OF BOLTS TO BE INSTALLED IN CONCRETE PRIOR TO AND DURING PLACEMENT OF CONCRETE WHERE ALLOWABLE LOADS HAVE BEEN INCREASED OR WHERE STRENGTH DESIGN IS USED.	-	x	ACI 318: 3.8.6, 8.1.3, 21.1.8	1908.5, 1909.1
4. INSPECTION OF ANCHORS INSTALLED IN HARDENED CONCRETE	-	x	ACI 318: 3.8.6, 8.1.3, 21.2.8	1909.1
5. VERIFY USE OF REQUIRED DESIGN MIX.	-	×	ACI 318: CH. 4, 5.2-5.4	1904.2, 1910.2 1910.3
6. AT THE THEE FRESH CONCRETE IS SAMPLED TO FABRICATE SPECIMENS FOR STRENGTH TESTS, PERFORM SILIMP AND AIR CONTENT TESTS, AND DETERMINE TEMPERATURE OF THE CONCRETE.	x	-	ASTM C 172 ASTM C 31 ACI 318: 5.6, 5.8	1910.10
 INSPECTION OF CONCRETE AND SHOTCRETE PLACEMENT FOR PRIOR APPLICATION TECHNIQUES. 	x	-	ACI 318: 5.9, 5.10	1910.6, 1910.7 1910.8
8. INSPECTION FOR MAINTENANCE OF SPECIFIED CURING TEMPERATURE AND TECHNIQUES.	-	x	ACI 318: 5.11, 5.13	1910.9
9. INSPECTION OF PRESTRESSED CONCRETE: A APPLICATION OF PRESTRESSING FORCES. B. GROUTING OF BORDED PRESTRESSING TENDONS IN THE SEISMIC-FORCE-RESISTING SYSTEM.	××	Ξ	ACI 318: 18.20 ACI 318: 18.18.4	1-
10. ERECTION OF PRECAST CONCRETE MEMBERS.	-	×	ACI 318: CH. 16	-
 VERIFICATION OF IN-SITU CONCRETE STRENGTH, PRIOR TO STRESSING OF TENDONS IN POSTTENSIONED CONCRETE AND PRIOR TO REMOVAL OF SHORES AND FORMS FROM BEAMS AND STRUCTURAL SLASS. 	-	×	ACI 318: 6.2	
12. INSPECT FORWWORK FOR SHAPE, LOCATION AND DIMENSIONS OF THE CONCRETE MEMBER BEING FORMED.	-	x	ACI 318: 6.2	1-

TABLE 1705.6 REQUIRED VERIFICATION AND INSPECTION OF SOILS					
VERIFICATION AND INSPECTION TASK	CONTINUOUS DURING TASK LISTED	PERIODICALLY DURING TASK LISTE			
 VERIFY MATERIALS BELOW SHALLOW FOUNDATIONS ARE ADEQUATE TO ACHIEVE THE DESIGN BEARING CAPACITY. 	-	x			
VERIFY EXCAVATIONS ARE EXTENDED TO PROPER DEPTH AND HAVE REACHED PROPER MATERIAL.	-	x			
3. PERFORM CLASSIFICATION AND TESTING OF COMPACTED FILL MATERIALS.	-	x			
4. VERIFY USE OF PROPER MATERIALS, DENSITIES AND LIFT THICKNESS DURING PLACEMENT AND COMPACTION OF COMPACTED FILL.	x	-			
5. PRIOR TO PLACEMENT OF COMPACTED FILL, OBSERVE SUBGRADE AND VERIFY THAT SITE HAS BEEN PREPARED PROPERLY.	-	x			

TABLE 17 REQUIRED VERIFICATION AND INSPECTION OF CA		ENTS
VERIFICATION AND INSPECTION	CONTINUOUS DURING TASK LISTED	PERIODICALLY DURING TASK LISTED
OBSERVE DRILLING OPERATIONS AND MAINTAIN COMPLETE AND ACCURATE RECORDS FOR EACH ELEMENT.	×	-
2. VERIFY PLACEMENT LOCATIONS AND PLUMBNESS, CONFIRM ELEMENT DUALETERS, BELL DIAMETERS (IF APPLICABLE), LENGTHS, EMBEDMENT INTO BEDROCK (IF APPLICABLE), AND ADEQUATE END-BEARING STRATA CAPACITY. RECORD CONCRETE OR GROUT VOLUMNS.	x	-
3. FOR CONCRETE ELEMENTS, PERFORM ADDITIONAL INSPECTIONS IN ACCORDANCE WITH SECTION 1704.4.	-	-

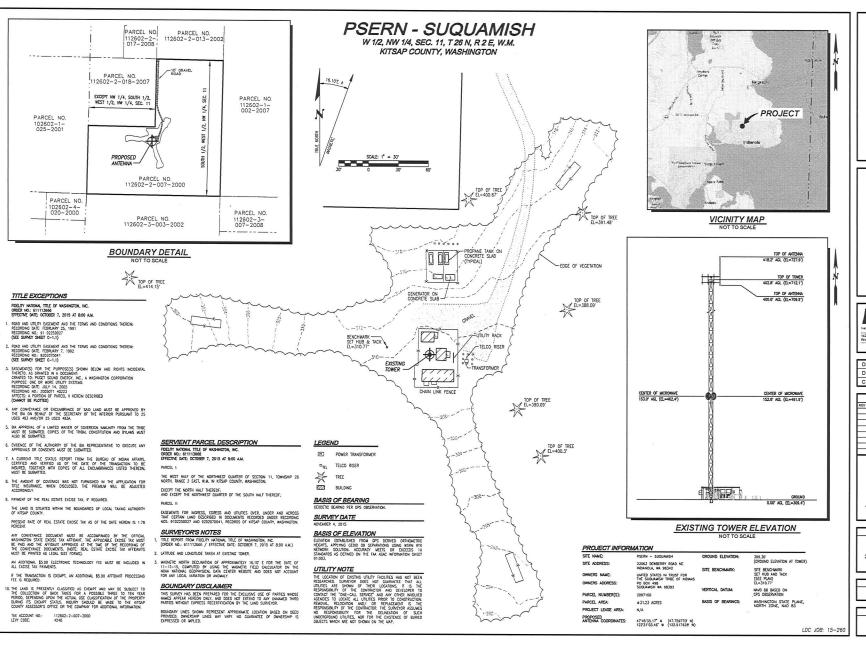






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CHECKED BY:	MRM

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SHEET TITLE CIVIL SURVEY

C-1.0





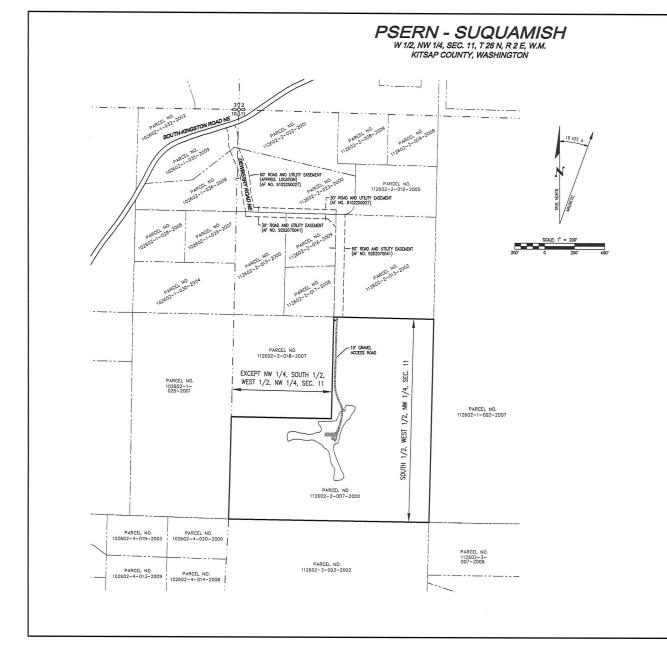

DATE:	11-12-15
DRAWN BY:	VJT
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SITE
PSERN
SUQUAMISH
22063 DEWBERRY ROAD NE
INDIANOLA, WA 98342

SHEET TITLE CIVIL SURVEY

C-1.1

LDC JOB: 15-260

SUQUAMISH

22063 DEWBERRY RD NE INDIANOLA, WA 98342

APPLICANT

ODELIA PACIFIC CORP 5506 6TH AVE 5, SUITE 202 5EATTLE, WA 98108 425.443.2128 CONTACT: MARK RILEY

CONSULTANTS ARCHITECT

CIVIL ENGINEER
CG ENGINEERING
250 4TH AVE 5, SUITE 200
EDMONDS, WA 98020
425.778.8500 FAX 778.5536
CONTACT: JARED UNDERBRI CAMP & ASSOCIATES 19401 40TH AVE W, SUITE 304 LYNNWOOD, WA 98036 425.740.6390 CONTACT: ERIC CAMP

SURVEYOR LDC 14201 NE 200TH ST. SUITE 100 WOODINVILLE 900. 2 425.806.1869 CONTACT: MICHAEL MERRITT

LEGAL DESCRIPTION

SOUTHWEST QUARTER OF THE NORTHWEST QUARTER EXCEPT THE FOLLOWING: THE NORTHWEST QUARTER OF THE SOUTHWEST QUARTER OF THE NORTHWEST QUARTER OF SECTION 11, TOWNSHIP 26 NORTH, RANGE 2 EAST, W.M., IN KITSAP COUNTY, WASHINGTON.

BENCHMARK

DATUM NAVD 88 BASED ON GPS OBSERVATION




CAUTION! CALL BEFORE YOU DIG!

BURIED UTILITIES EXIST IN THE AREA AND UTILITY INFORMATION SHOWN MAY NOT BE COMPLETE. CONTACT THE ONE-CALL UTILITY LOCATE SERVICE A MINIMUM OF 48

1-800-424-5555

IMPERVIOU	S SURFA	CES	Г		SHEET INDEX
NEW - REPLACED -	1,060	SQ FT	CI	.1	COVER SHEET & GENERAL NOTES
TOTAL	1.060	SQ FT	C	.1	TEMPORARY EROSION CONTROL PLAN
			C	.2	TEMPORARY EROSION CONTROL DETAIL
			C3	.1	GRADING & DRAINAGE PLAN

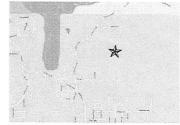

PROJECT SITE







SUQUAMISH

(NEW BUILD)

22063 DEWBERRY RD NE INDIANOLA WA 98342



5506 6TH AVE, S. SUITE 202



CG PROJECT# 16015.914

PREPARED BY

APPROVED BY

ZOS

GAG

REV DATE DESCRIPTION

PLAN REVIEWERS SIGNATURE

COVER SHEET AND GENERAL

> SHEET NUMBER C1.1

GENERAL NOTES

- ALL WORKMANSHIP AND MATERIALS SHALL CONFORM TO THE MOST CURRENT STANDARD SPECIFICATIONS FOR ROAD, BRIDGE AND MUNICIPAL CONSTRUCTION PREPARED BY WISDOT AND BYM AS ADOPTED BY THE KITSA COUNTY DEPARTMENT OF PUBLIC WORKS (ICCPW).
 ANY REVISIONS TO THE ACCEPTED CONSTRUCTION PLANS SHALL BE REVIEWED.

- ANY BIVISIONS TO THE ACCEPTED CONSTRUCTION PLANS SHALL BE REVIEWED AND ANY PROVIDED THE COUNTY PROLET OR IMPLEMENTATION IN THE FIELD. THE CONTRACTION IS THE COUNTY PROLET OR IMPLEMENTATION IN THE FIELD. THE CONTRACTION SHALL MAINTAIN A SET OF THE ACCEPTED CONSTRUCTION DAVINGS OF THE ALL THATE WHITE CONTRACTION OF PROGRESS. WITHOUT ANY PROPERTY OF THE COUNTY OF THE
- OF THE COMMERCENCENT OF ANY CONSTRUCTION ALTOTTY. THE CONTRACTOR SHALL PROVIDE FOR PROTECTION OF EXISTING UTILITIES FROM DAMAGE CAUSED BY THE CONTRACTOR'S OPERATIONS.

 ROCKERIES OR OTHER RETAINING FACILITIES EXCEEDING 4 FT. IN HEIGHT REQUIRE A SPARART PERMIT
- A "FORESTRY PRACTICES" PERMIT MAY BE REQUIRED PRIOR TO CLEARING OF THE

EROSION CONTROL NOTES

- THE FOLLOWING EROSION AND SEDIMENTATION CONTROL NOTES APPLY TO ALL CONSTRUCTION STIR ACTIVITIES AT ALL TIMES, UNLESS OTHERWISE SPECIFIED ON THISE F ALAIS. THESE F ALAIS.

 APPROVAL OF THIS EROSION AND SEDIMENTATION CONTROL I PAIN DOES NOT APPROVAL OF THIS EPOSION AND SEDIMENTATION CONTROL I PAIN DOES NOT CONSTITUTE AN ACCESTRACE OF THE PERMANENT ROAD OF DRAINAGE DESIGN. THE OWNER AND HIS/HET CONTRACTOR SHALL BE RESPONSIBLE AT ALL TIMES FOR PREVENTING SUIT-ARDER NUMBER FOR THE OWNER OFFICE THE ADMINISTRATION DESCRIBED FOR OWN THE PROJECT. FOR PREVENTING SILT-LADEN RUNGF FROM DISCHARGING FROM THE PROJECT STIE. FAILURE STHE OWNER AND/OR CONTRACTOR CAN RESULT IN A FINE. THE DESIGNATED TEMPORARY CONTACT PERSON NOTED ON THIS PLAN MUST BE AVAILABLE FOR CONTACT BY TELEPHONE ON A 24 HOUR BASIS THROUGHOUT CONSTRUCTION AND UNTIL THE PROJECT HAS BEEN COMPLETED AND ACCEPTED
- CONSTRUCTION AND LIMIT. HE PROJECT HAS ESSEN CONFLETE AND ACCEPTED BY HE COUNTY.

 FOR THE COUNTY.

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- PERMANENT DETENTION/RETENTION PONDS, PIPES, TANKS OR VAULTS MAY ONLY BE USED FOR SEDIMENT CONTAINMENT WHEN SPECIFICALLY INDICATED IN THESE BLANC

GRADING NOTES
THE CONTRACTOR SHALL NOTIFY THE ENGINEER IN THE EVENT OR DISCOVERY OF
POOR SOLIS, GROUNDWATER OR DISCREPANCIES IN THE EXISTING CONDITIONS AS
NOTED ON THE PLANS.

- MAXIMUM SLOPE STEEPNESS SHALL BE 2:1 (HORIZONTAL TO VERTICAL) FOR CUT.
- AMAZIMUM SALVES I ISEPNISOS SHALL SE ZI (MURICIPATA TO VERTICAL) POR CUT
 MURISS OTHERWISE SPECIFIED, ALL BERNAMMENTS IN THE PANA ST SHALL BE SELVEN SEPECIFIED. ALL BERNAMMENTS IN THE PANA ST SHALL BE STANARIO SPECIFICATIONS. EMBANIMENT COMPACTIONS SALL CONFORM TO
 SECTION 2-0.3.1146, METHOD B OF SALD STANARIO SPECIFICATIONS.

 BERNAMMENTS DESIGNED TO IMPOUND WATER SHALL BE COMPACTED TO 95%


 MAXIMUM DENSITY FOR SECTION 2-0.3.1146, METHOD C OF WISDOT STANDARD

 SECCICATIONS.
- SPECIFICATIONS.
 AL LARGS RECEIVING FILL MATERIAL SHALL BE PREPARED BY REMOVING VIGETATION, NON-COMPLIVES FILL, TOPSOL AND OTHER UNGULTRARE VIGETATION, NON-COMPLIVES FILL, TOPSOL AND OTHER UNGULTRARE VIGETARIAN THE SURFACE TO PROVIDE A RODE WITH THE NEW FILL, AND WHERE SLOPES ARE STEEPER THAN 3 HORROWITAL TO I VERTICAL AND THE HEIGHT IS GREATER THAN SET, SE PRESICHANIS INTO SOUND COMPETENT MATERIAL AS DETERMINED BY A SOILS ENGINEER.

- 1. APPLY FOR AND PICK UP ANY RIGHT OF WAY PERMITS FROM KITSAP COUNTY

- APPLY FOR AND PICE UP ANN RIGHT OF WAY PERMITS FROM SITAP COUNTY DEPARTMENT OF PUBLIC WORK.
 CORSTRUCT STABLEDGE CONSTRUCTIONS ENTRANCISE).
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		LEGENI)				
DESCRIPTION	EXISTING PROPOSED ABBREVIATIONS						
PROPERTY LINE			ABN	ABANDONED	MIN	MINIMUM	
ADJACENT PROPERTY LINE	I		BLDG	BUILDING	MJ	MECHANICAL JOINT	
CENTERLINE			BOW	BOTTOM OF WALL	MON	MONUMENT	
CLEARING LIMITS		·····	E	CENTERLINE	NTS	NOT TO SCALE	
SILT FENCE	y x	— x—— x——	СВ	CATCH BASIN	ос	ON CENTER	
CONTOUR LINE			CMP	CORRUGATED METAL PIPE	PC	POINT OF CURVATURE	
FENCE		-0-0-0-	co	CLEANOUT	PI	POINT OF INTERSECTION	
SANITARY SEWER LINE		ssss	CONC	CONCRETE	PIV	POST INDICATOR VALVE	
MANHOLE	0	0	CONST	CONSTRUCTION	9	PROPERTY LINE	
STORM DRAIN MAIN		soso	CP	CONCRETE PIPE	PT	POINT OF TANGENCY	
STORM DRAIN PIPE			CU YD	CUBIC YARD	PVC	POLYVINYL CHLORIDE PIP	
ROOF DRAIN		RR	DDCVA	DOUBLE DETECTOR CHECK VALVE ASSEMBLY	PVI	POINT OF VERTICAL INTERSECTION	
FOOTING DRAIN	!!-	rr	DI	DUCTILE IRON PIPE	PVMT	PAVEMENT	
PRESSURE LINE			DIA	DIAMETER	PVT	POINT OF VERTICAL TANK	
CATCH BASIN (TYPE 1)	Ð		DIP	DUCTILE IRON PIPE	R	RADIUS	
CATCH BASIN (TYPE 2)	0	•	EA	EACH	REINF	REINFORCEMENT	
CLEANOUT	,	•	EJ	EXPANSION JOINT	RJ	RESTRAINED JOINT	
CLEANOUT AND WYE		7.	ELEV	ELEVATION	RET	RETAINING	
GRADE BREAK			EOP	EDGE OF PAVEMENT	RT	RIGHT	
SURFACE SWALE	\$***** }*****	· - · ·	EX	EXISTING	SD	STORM DRAIN	
DRAINAGE ARROW			FDC	FIRE DEPT. CONNECTION	SECT	SECTION	
WATER LINE		—— WA——— WA———	FFE	FINISHED FLOOR ELEVATION	SDMH	STORM DRAIN MANHOL	
WATER METER	Ell	52	FH	FIRE HYDRANT	SIM	SIMILAR	
FIRE HYDRANT	12.	à	FL	FLANGE	SQ	SQUARE	
FDC	ত	₩	FT	FEET/FOOT	SS	SANITARY SEWER	
PIV	0	•	GV	GATE VALVE	SSMH	SANITARY SEWER MANHOLE	
GATE VALVE	Z	I	HP	HIGH POINT	STA	STATION	
TEE		Д	HT	HEIGHT	STD	STANDARD	
90" BEND	3	Ľ	ID	INSIDE DIAMETER	STL	STEEL	
THRUST BLOCKING	a	A	18	INVERT ELEVATION	тв	THRUST BLOCK	
CAP	· ·	u	L	LENGTH/LINE	TOC	TOP OF CURB	
CONCRETE PAVEMENT		4 4 4 4	LCPE	LINED CORRUGATED POLYETHYLENE PIPE	TOW	TOP OF WALL	
ASPHALT PAVEMENT			LF	LINEAL FOOT	TOP	TOP ELEVATION	
CRUSHED SURFACING			LP	LOW POINT	TYP	TYPICAL	
ROCKERY	0000000000	0000000000	LT	LEFT	vc	VERTICAL CURVE	
SPOT ELEVATION	₹ 36.0	₹ 20.0	MAX	MAXIMUM	w/	WITH	
TELEPHONE LINE			MECH	MECHANICAL	WM	WATER METER	
POWER LINE			мн	MANHOLE			
GAS LINE							
SIGN							

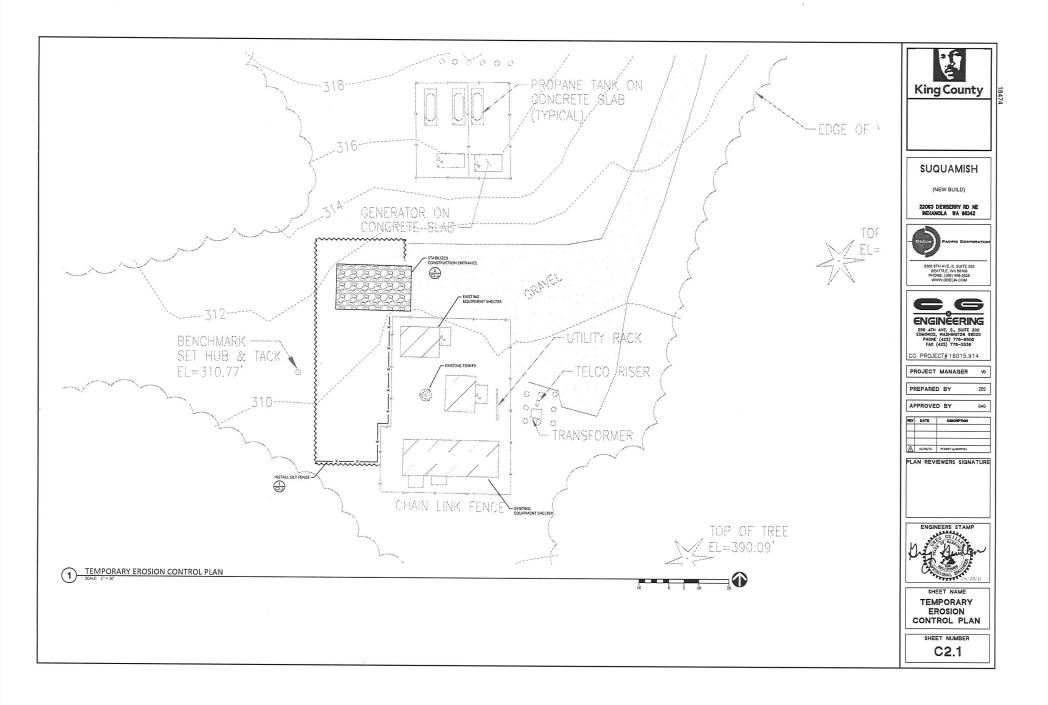

22063 DEWBERRY RD NE INDIANOLA WA 98342



5506 6TH AVE, S. SUITE 202 SEATTLE, WA 98108 PHONE: (206) 490-3826 WWW.ODELIA.COM



250 4TH AVE. S., SUITE 200 EDMONDS, WASHINGTON 98020 PHONE (425) 778-8500 FAX (425) 778-5536 CG PROJECT# 16015.914

PROJECT MANAGER

PREPARED BY

APPROVED BY

NEV D	ATE	DESCRIPTION	
+	-		

ZOS

PLAN REVIEWERS SIGNATURE



SHEET NAME **TEMPORARY EROSION** CONTROL DETAILS


SHEET NUMBER

C2.2

 FILTER FABRIC MATERIAL 36" MIN WIDE ROLLS. USE STAPLES OR WIRE RINGS TO ATTACH FABRIC TO WIRE. JOINTS IN FILTER FABRIC SHALL BE SPLICED AT POSTS. FILTER FABRIC MATERIAL 2"x2" BY 14 GA. WIRE FABRIC OR EQUIVALENT 2"x2" BY 14 GA WIRE FABRIC OR EQUIV IF STANDARD STRENGTH FABRIC IS USED 6"x6" MIN TRENCH BACKFILL TRENCH WITH NATIVE SOIL OR 3/4" WASHED ROCK BURY BOTTOM OF FILTER
MATERIAL IN 6"x6" TRENCH 2"x4" WOOD POSTS, STANDARD

OR BETTER OR EQUAL ALTERNATE: STEEL FENCE POSTS

SILT FENCE SCALE: 1/2" = 1'-0" (1)-

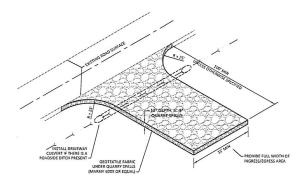

SILT FIRST HARD, SHALL BE MIRRAT TOOL OR APPROVED EQUAL, AND SHALL BE PURCHASED IN A CONTINUOUS ROLL
CUTTO THE LENGTH OF THE BLANKER TO AVOID USE OF JOINT, WHICH JOINT AS MICKESARY, PLITTE COTH SHALL
BY JULED TO DEPIRE OWN AT A SUPPORT FOOT, WITH A MINIMUM BINNED CHEERA, AND BOTH LIBES SECURITY
2. THE ATT FRACE SHALL BE MATALLED TO FOLIOUT HE CONTIOUS (WHITE FEARIBLE). THE FIRST POST SHALL BE
3-PACED A MARMING OF FEET ASKAT AND DRIVEN SECURITY WITH OTH GOOD (MINIMUM OF I SHORT).

3. AS DALLOW TRENCH SHALL BE EXCLANTED, MOUNT IS INCHES WITE AND BINNED SECURITY SHALL BE
3-PACED A MARMING OF FEET ASKAT AND DRIVEN SECURITY WITH THE GOOD (MINIMUM OF I SHORT).

3. AS DALLOW TRENCH SHALL BE EXCLANTED, MOUNT IS INCHES WITH AND BINNED SECURITY.

4. WHINN INITE RABBE CHT AST STORE AS MARKET FORCE SHALL AND BINNED SECURITY.

5. THE MINIMUM SHALL BE AND A MARKET FORCE SHALL AND A WITH MENS HEAVING OF A ROSE AND SHALL BE A STATEMED SECURITY TO THE UPLANCE SHOLD HE HOUSE HEAVING. AND HE HAVE AND SHALL BE A STATEMED SECURITY TO THE UPLANCE SHALL BE ADDITED.

5. THE MINIMUM SHALL BE AND THAN AND HEAVING AND THE AND SHALL BE A STATEMED TO THE FERKEL, AND A TELEST IS BUCHES OF THE ADDITED.

6. WHINN ITEMS AND THAN AS IN MORE ARROWS THE ORIGINAL CONTROL RETAINED AND THE DOTTED MINIMUM THAN HE MINIMUM THE ADDITED.

7. THE TRENCH SHALL BE RECONFILED WITH MATTING SOLD AND HEAVING THE SHALL BE STATEMED TO THE FORCE AND SHALL BE STATEMED THE THE PASS OF THE MORE STATEMED AND THE ADDITED.

7. THE TRENCH SHALL BE MARCHAILTY STABLED ON THE NEWLY OF THE WINNED AND AS EXCLUSIVE SHALL BE STATEMED THE OFFICE AND THE MINIMUM SHALL BE STATEMED TO THE FORCE AND AS EXECUTION OF THE MORE STATEMED THE THE PASS OF THE MORE STATEMED THE ADDITED.

8. WHEN THE THE PASS OF THE MORE STATEMED THE PASS OF THE MORE STATEMED THE ADDITED.

9. THE TRENCH SHALL BE RECONTROL OF THE MORE STATEMED THE PASS OF THE MO

INGINITALL ANY INCLUDING MEPAINS SHALL BE MADE IMMEDIATELY.

IO.MAINTENANCE: ANY DAMAGEO OR CLOGGEOF PENCE SHALL BE REPAIRED/REPLACED IMMEDIATELY, SEDIMENT MUST BE REMOVED WHEN THE SEDIMENT DEPTH IS 6 INCHES OR GREATER. IF CONCENTRATED FLOWS ARE EVIDENT UPHILL OF THE FENCE, THEY MUST SE INTERCEPTED AND CONVEYED TO A SEDIMENT TRAP OR FOND.


STABILIZED CONSTRUCTION ENTRANCE NOTES:


- 2. RESTAULTION THE ABLA OF THE ENTRANCE SHOULD BE FLURAD OF ALL VIGITATION, ROOD AND DYTHE OBJECTIONING.
 MATTRIAL THE QUARRES SHALL SHOULD BE FLURAD TO THE VIEW THE OBJECTION OF THE VIEW BY AND THE ABLA THE REQUIRED REQ


SILT FENCE NOTES:


- AND SHAPE OF THE STREAM CAN BE CARRED FOR THE SHAPE AND SHAPE AT LEAST ISO HET (UNILSS OTHERWISE APPRING A PARKET AND SHAPE AN


STABILIZED CONSTRUCTION ENTRANCE (2)

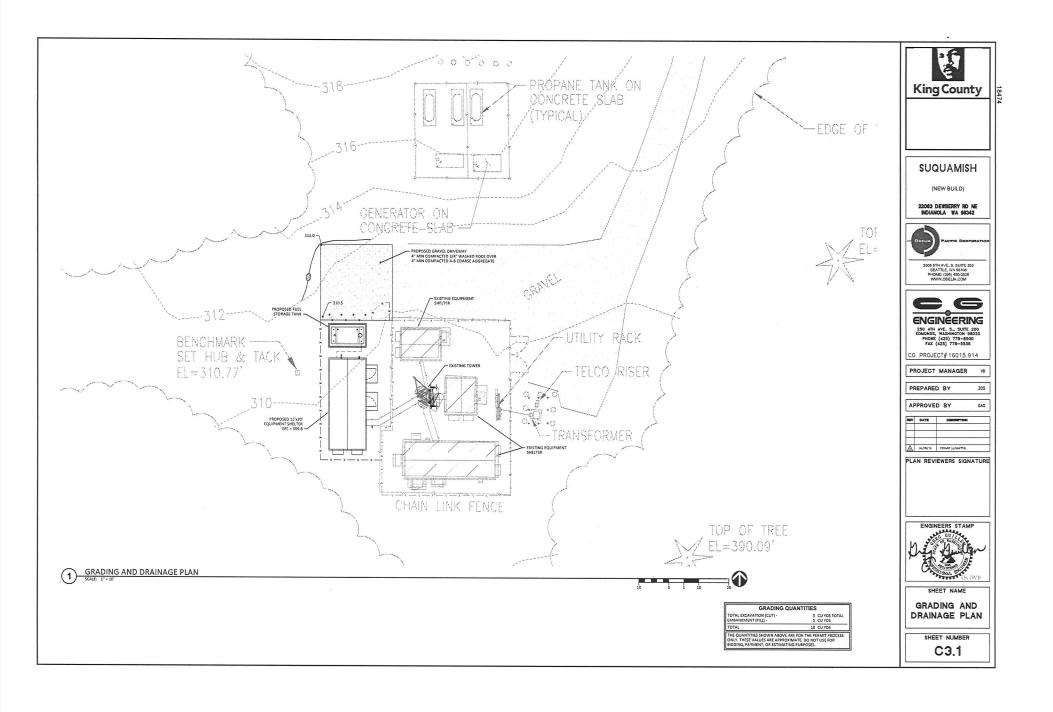


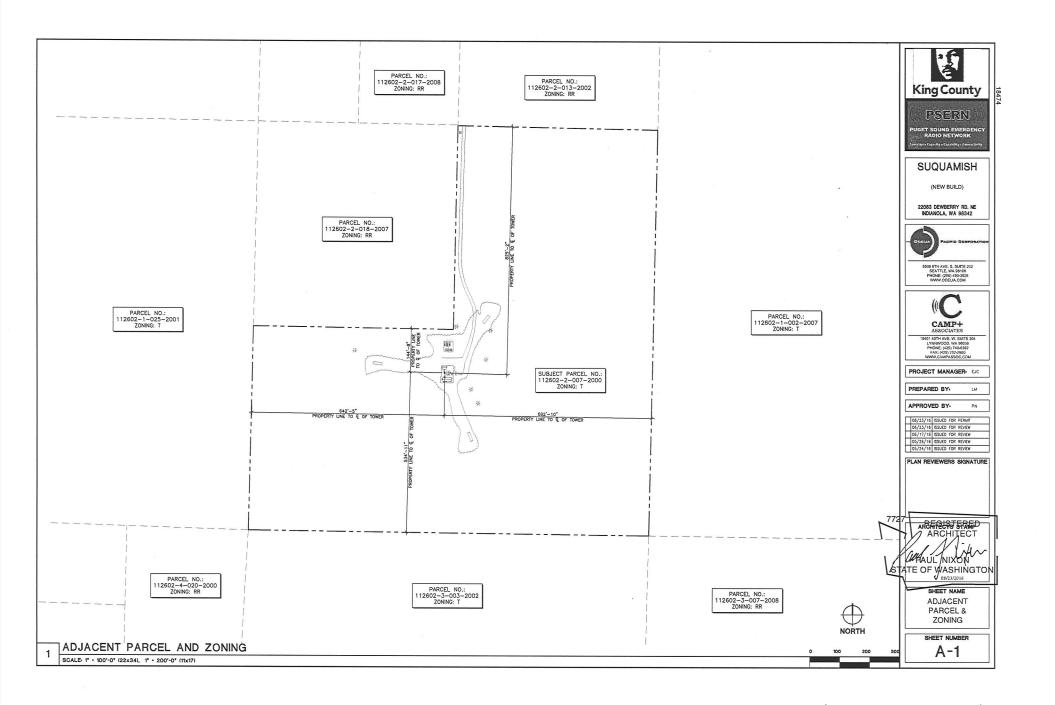


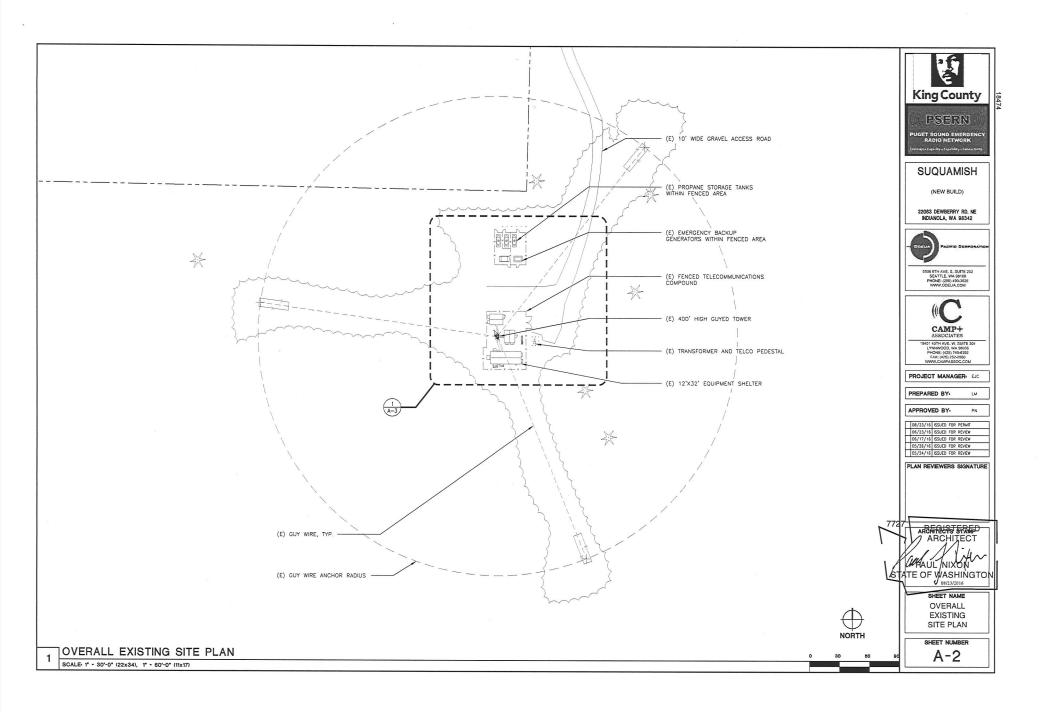


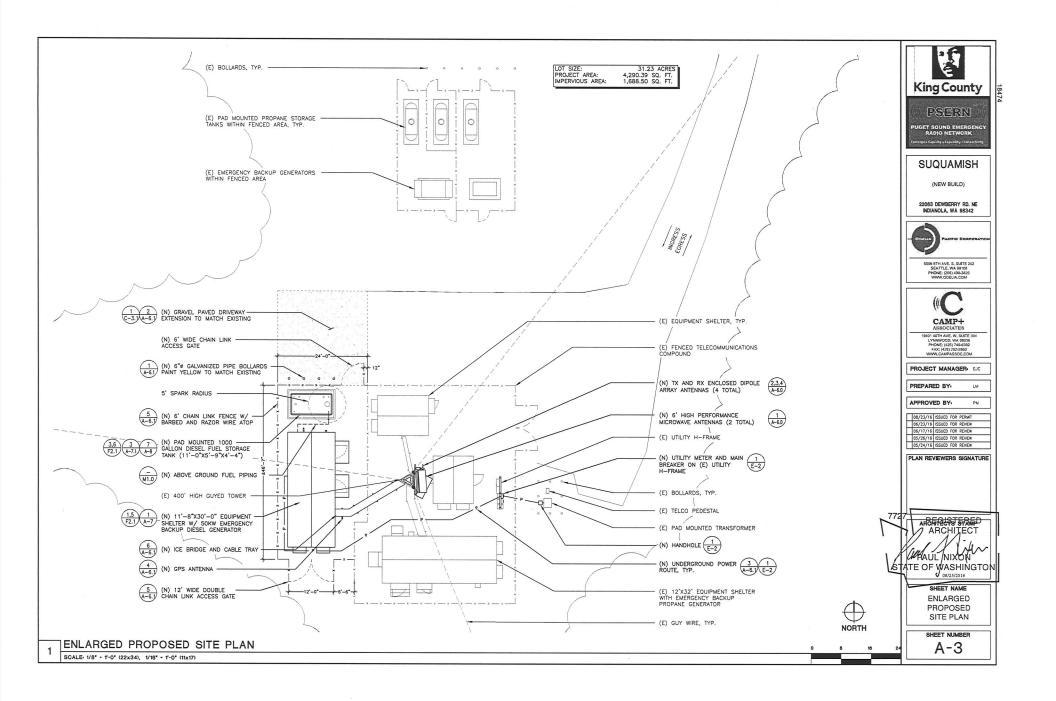


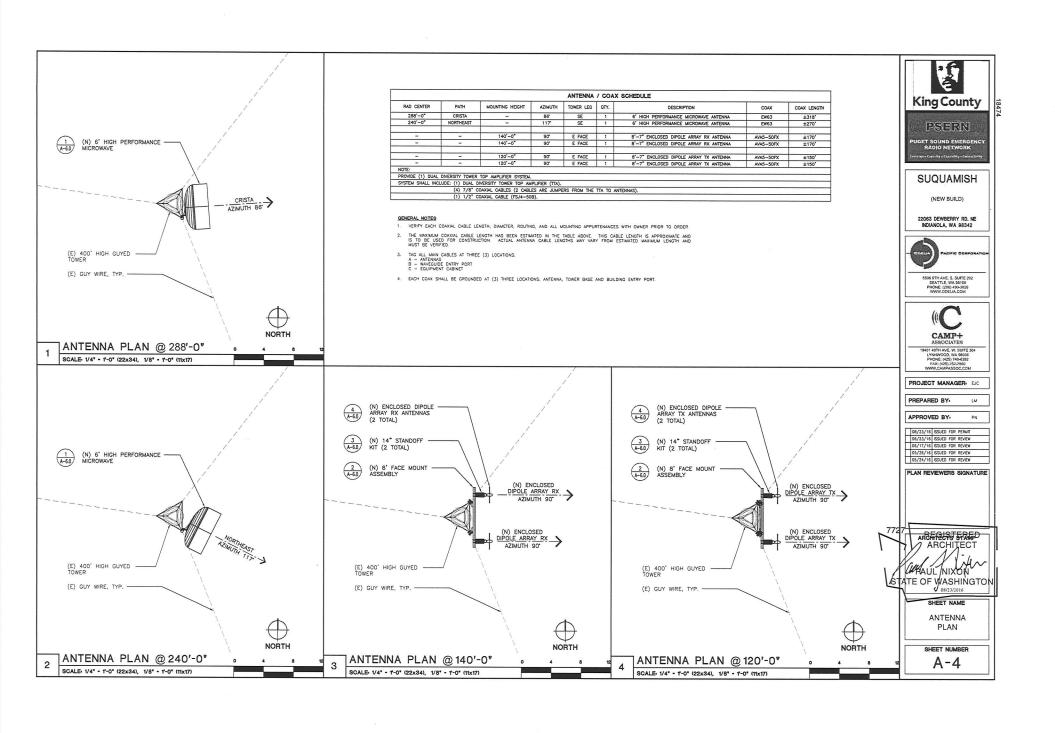


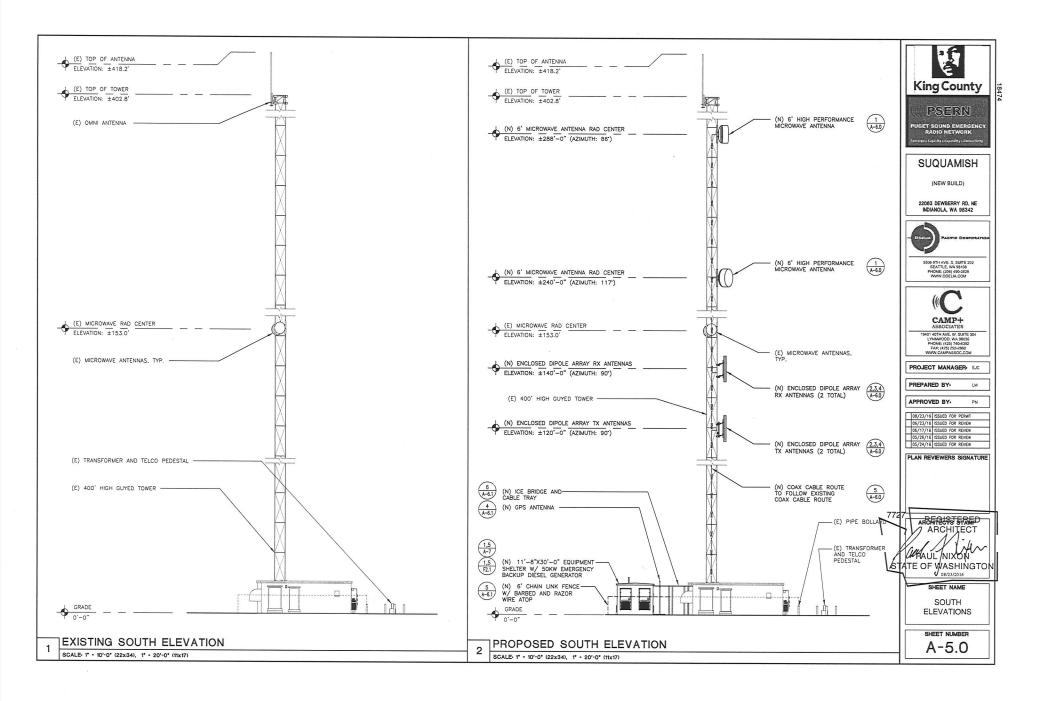


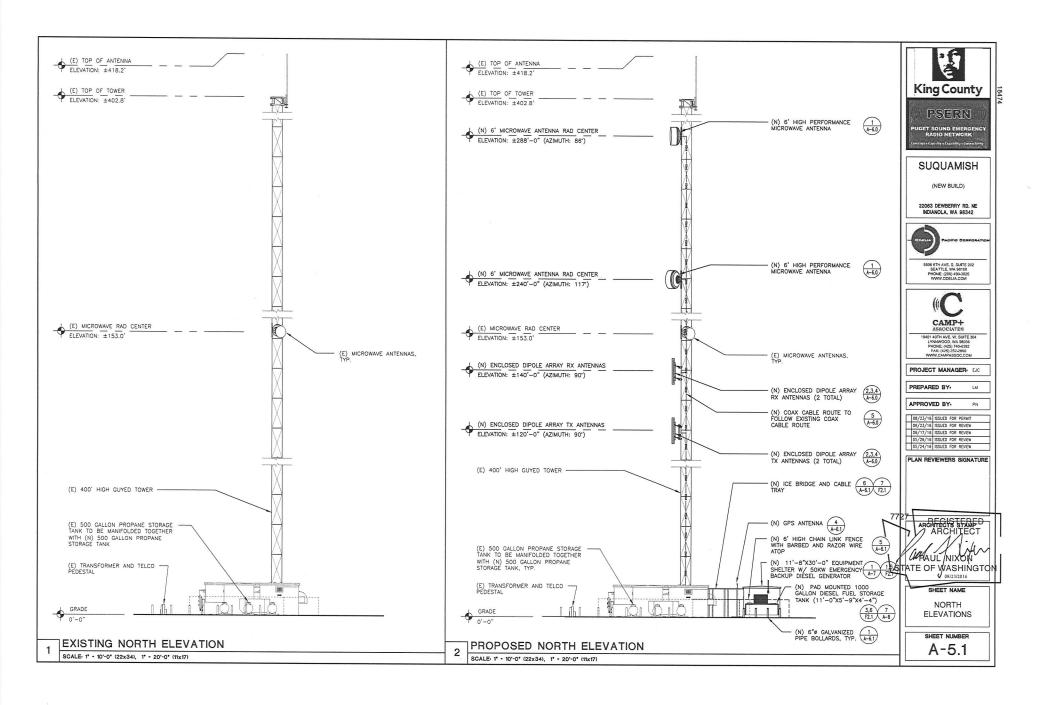

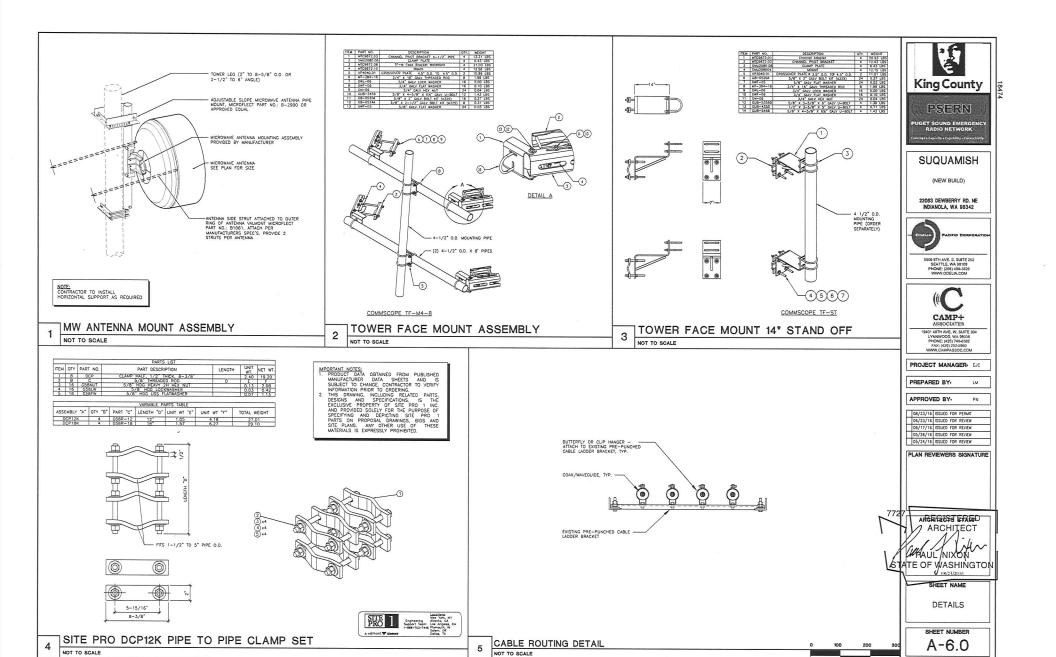

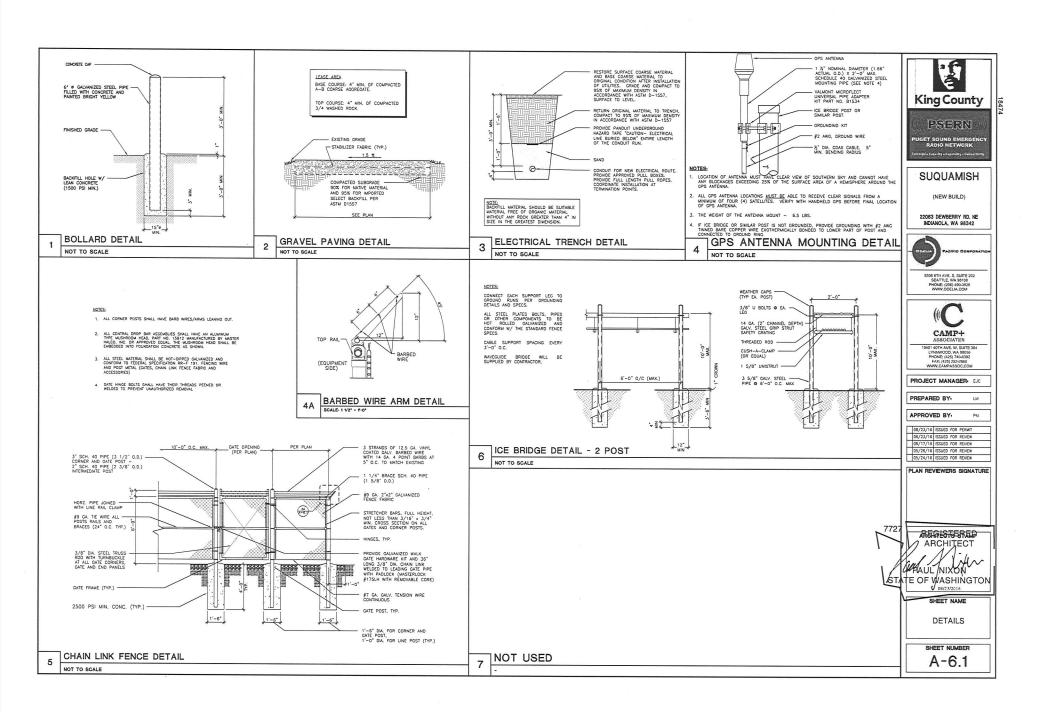

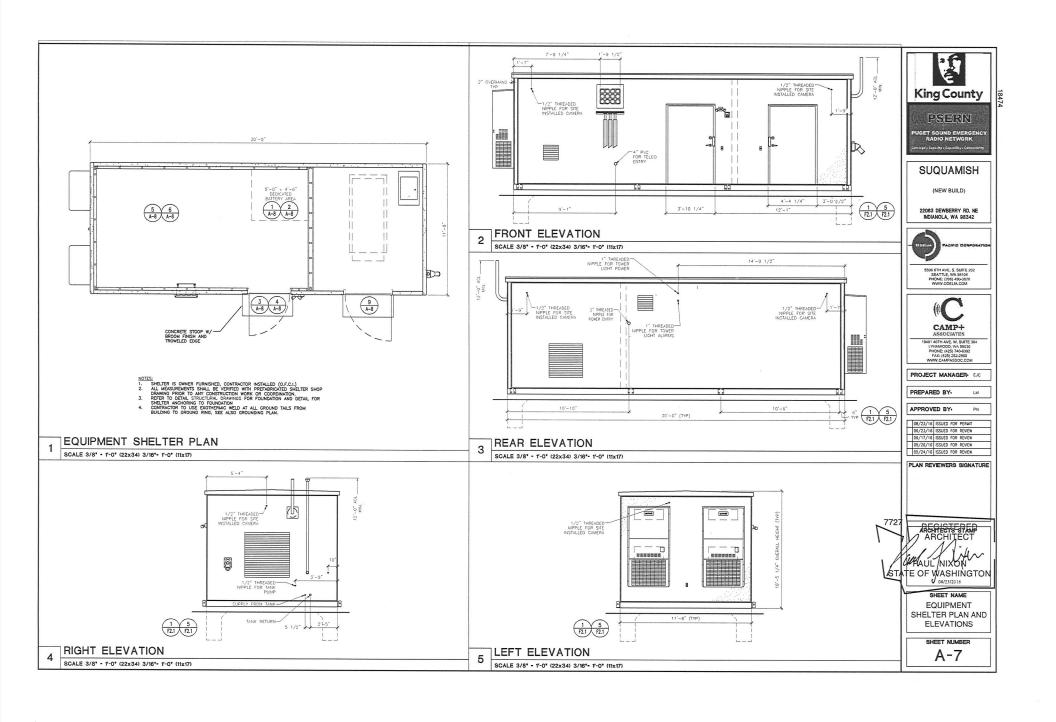

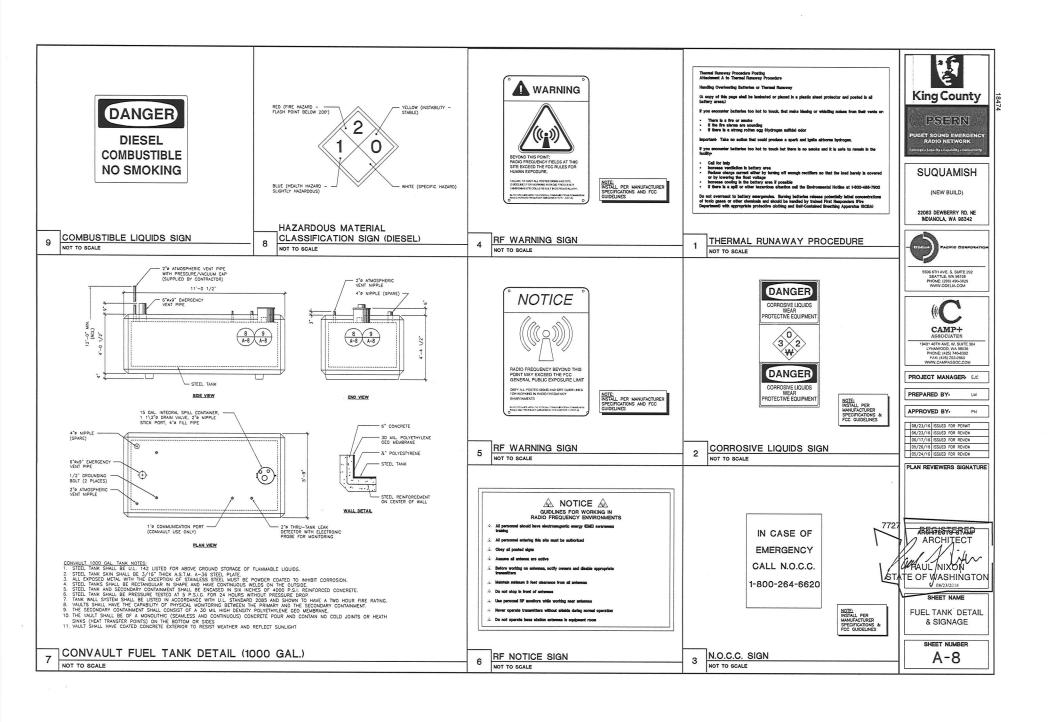

CODE

ALL MATERIALS, WORKMANSHIP, DESIGN, AND CONSTRUCTION SHALL CONFORM TO THE DRAWINGS, SPECIFICATIONS, AND THE INTERNATIONAL BUILDING CODE (IRIG.), 2015 EDITION, SPECIFICATIONS AND STANDARDS WHERE REFERENCED ON THE DRAWINGS ARE TO 8E THE LATEST EDITION.

DEAD LOADS:	
BUILDING WEIGHT	100.5 KIPS (80 KIPS SELF WT + 20.5 KIPS EQUIPME
FUEL TANK	27 KIPS (18 KIPS SELF WT + 9 KIPS FUEL)

ROOF (SNOW LOAD)
ROOF LIVE

(LIVE LOADS ARE REDUCED WHERE PERMISSIBLE PER IBC SECTION 1607.10).

EARTHQUAKE LOADS:

EXPOSURE

SITE CLASS (ASSUMED)	D
SHORT PERIOD SPECTRAL RESPONSE ACCEL (S.)	1.277
ONE SECOND SPECTRAL RESPONSE ACCEL (S)	0.507
SHORT PERIOD DESIGN SPECTRAL RESPONSE ACCEL (S.e.)	0.852
ONE SECOND DESIGN SPECTRAL RESPONSE ACCEL (S.)	0.507
RISK CATEGORY	IV
SEISMIC IMPORTANCE FACTOR (I,)	1.5
SEISMIC DESIGN CATEGORY	D
LOADS:	

BASIC WIND SPEED (3 SECOND GUST) SEE PLANS FOR ADDITIONAL DESIGN LOADS.

STATEMENT OF SPECIAL INSPECTIONS

SPECIAL INSPECTIONS ARE REQUIRED AS INDICATED IN THE FOLLOWING TABLE. THE CONTRACTOR SHALL SUBMIT A WRITTEN STATEMENT OF RESPONSIBILITY TO THE BUILDING OFFICIAL AND OWNER PRIOR TO COMMENCEMENT OF WORK IN ACCORDANCE WITH CHAPTER 1704.4 OF THE JOY.

115 MPH

FREQUENCY AND DISTRIBUTION OF REPORTS - INSPECTION REPORTS SHALL BE PROVIDED FOR EACH DAY ON SITE BY SPECIAL INSPECTOR, STRUCTURAL OBSERVATION REPORTS SHALL BE PROVIDED AFTER EACH OBSERVATION, REPORTS SHALL BE DISTRIBUTED TO THE CONTRACTOR, ARCHITECT, ENGINEER AND BUILDING OFFICIAL.

SPECIAL INSPECTION

OPERATION	CONT	PERIODIC	REMARKS
SOILS			
EXCAVATION & FILL		x	GEOTECH ENGINEER
FOUNDATION BEARING CAPACITY VERIFICATION		X	
CONCRETE			
REINFORCING PLACEMENT		×	
ANCHOR BOLTS		x	
CONCRETE PLACEMENT	х		
EXPANSION ANCHORS		X	IF REQ'D

INDITE:
ALTITUMS MARKED WITH AN "X" SHALL BE INSPECTED IN ACCORDANCE WITH IBC CHAPTER 17. SPECIAL
IMSPECTION SHALL BE PERFORMED BY A QUALIFIED TESTING AGENCY DESIGNATED BY THE OWNEE, THE
ARCHITECT, STRUCTURAL ENSINEER, AND BUILDING OFFICIAL SHALL BE FURNISHED WITH COPIES OF ALL
RESULTS, ANY INSPECTION FALING TO MEET THE PROJECT SPECIFICATIONS SHALL BE IMMEDIATELY
BROUGHT TO THE ATTENTION OF THE DESIGN TEAM.

JUNDATIONS.		
DILS REPORT:	NO.	N/A
	BY	N/A
	DATED	N/A

2000 PSF (ASSUMED, TO BE FIELD VERIFIED DURING CONSTRUCTION) ALLOWABLE SOIL PRESSURE: 350 PSF (ASSUMED, TO BE FIELD VERIFIED DURING CONSTRUCTION)
0.35 (ASSUMED, TO BE FIELD VERIFIED DURING CONSTRUCTION)

FOOTINGS SHALL BEAR ON FIRM UNDISTURBED EARTH OR ENGINEERED GRAVEL FILL AS REQUIRED AND AT TEGET 18* BELOW ADJACENT CREEKING RADE, ANY FOOTHNS ELEVATIONS SHOWN IN THE PRAYMOS REPRESENT MINIMUM DEPTHS AND ARE FOR BIDDING ONLY, ACTUAL FOOTHNS ELEVATIONS ARE SUBJECT TO SITE CONDITIONS AND MUST THEEFEOR BE ESTABLISHED BY THE CONTRACTOR, FOOTHNS SHALL BE CENTERED BELOW COLUMNS OR WALLS ABOVE, UNLESS NOTED OTHERWISE.

IMPORTED STRUCTURAL FILL AND BACKFILL MATERIAL SHOULD CONSIST OF CLEAN, WELL GRADED GRANULAR MATERIAL FREE OF DEBILS OR ORGANICS WITH A MAXIMUM PARTICLE DIAMETER OF THREE INCHES AND NO MORE THAN 10% FINES [PASSING THE #200 SIEVE].

FILL AND BACKFILL MATERIAL SHOULD BE PLACED IN LEVEL LIFTS NOT EXCEEDING TWELVE (12") INCHES IN LOOSE THICKNESS AND COMPACTED TO A MINIMUM OF 98% OF ITS MAXIMUM DRY DENSITY AS DETERMINED BY ASTM TEST METHOD D1557-00.

EXCAVATIONS AND DRAINAGE INSTALLATION SHALL BE OBSERVED BY A SOILS ENGINEER RETAINED BY THE OWNER. IF EXCAVATION SHOWS SOIL CONDITIONS TO BE OTHER THAN THOSE ASSUMED ABOVE NOTIFY THE STRUCTURAL REINIEER FOR POSSILE FOUNDATION REDESIES.

CONCRETE

ALL CONCRETE SHALL BE MIKED, PROPORTIONED, CONVEYED, AND PLACED IN ACCORDANCE WITH SECTION CHAPTER 5 OF ACI 318 AND THE AMERICAN CONCRETE INSTITUTE'S SPECIFICATIONS FOR STRUCTURAL CONCRETE FOR BUILDINGS (ACI 301).

ALL CONCRETE SHALL BE STONE-AGGREGATE CONCRETE HAVING A UNIT WEIGHT OF APPROXIMATELY 150

CONCRETE STRENGTHS AT 28 DAYS (Fc) AND MIX CRITERIA SHALL BE AS FOLLOWS:

TYPE OF CONSTRUCTION	fe	MAXIMUM WATER/CEMENT RATIO	MIN CEMENT CONTENT PER CUBIC YARD	MAXIMUM SHRINKAGE STRAIN
SLABS ON GRADE	3000 PSI	. 0.55	5 1/2 SACK	N/A
FOOTINGS	3000 PSI	0.55	5 1/2 SACK	N/A
GRADE BEAMS	3000 PSI	0.50	5 1/2 SACK	N/A
ALL OTHER CONC.	2500 PSI	0.45	5 SACK	N/A

THE MINIMUM AMOUNT OF CEMENT LISTED ABOVE MAY BE CHANGED IF A CONCRETE PERFORMANCE MIN IS SUMMITTED TO THE ENRINKER AND THE BUILDING CEPARTMENT FOR APPROVAL TWO WEEKS PRIOR TO EXCHANGE AND THE ENRINKER AND THE BUILDING CEPARTMENT FOR APPROVAL TWO WEEKS PRIOR TO EXCHANGE THE PERFORMANCE MIN SHALL LOUGH THE AMOUNTS OF CEMENT, FINE AND COMMETCE WILL AND ADMITTURES AS WELL AS THE WATER-CEMENT RATIO, SLUMP, COMMETER THE AND ADMITTURES AS WELL AS THE WATER-CEMENT RATIO, SLUMP,

REINFORCING STEEL

REINFORCING STEEL SHALL BE DEFORMED BILLET STEEL CONFORMING TO ASTM A615. AND SHALL BE GRADE 60 (Fy = 50,000 PSI), UNILESS NOTED OTHERWISE. GRADE 60 REINFORCING BARS INDICATED ON DRAW!
TO BE WELDED SHALL CONFORM TO ASTM A 706, REINFORCING COMPLYING WITH ASTM AGIS MAY BE
WELDED IF MATERIAL PROPERTY REPORTS INDICATING CONFORMANCE WITH WEI DING PROFEDURES. SPECIFIED IN AWS D1.4 ARE SUBMITTED.

WELDED WIRE FABRIC SHALL CONFORM TO ASTM A185, PROVIDE WELDED WIRE FABRIC IN SHEETS NOT ROLLS. LAP WELDED WIRE FABRIC 12" AT SIDES AND ENDS.

REINFORCING STEEL SHALL BE DETAILED INCLUDING HOOKS AND BENDS IN ACCORDANCE WITH SP-66 AND ACT 318R, LATEST EDITIONS, UNLESS OTHERWISE NOTED, REINFORCING SPLICE LENGTHS AND DEVELOPMEN ACI 318R, LATEST EDITIONS. UNLESS LENGTHS SHALL BE PER SCHEDULE.

MECHANICAL SPLICING OF REINFORCING BARS, WHERE INDICATED ON THE DRAWINGS, SHALL BE BY AN ICBO APPROVED SYSTEM. SHALL DEVELOP 125% OF THE SPECIFIED YIELD STRENGTH OF THE BAR, AND SHALL CBO APPROVED SYSTEM, SHALL DEVELOP 125% OF THE SPECIFIED YIELD STRENG IP BE INSTALLED IN ACCORDANCE WITH THE MANUFACTURER'S RECOMMENDATIONS

REINFORCING SHALL BE PLACED AND ADEQUATELY SUPPORTED PRIOR TO PLACING CONCRETE.
WET-SETTING EMBEDDED TEMS IS NOT ALLOWER WITHOUT PRIOR ENGINEER APPROVAL, BARE PARTIALLY
EMBEDDED IN HARDENED CONCRETE SHALL NOT BE FIELD BENT UNLESS SO DETRILED OR APPROVED BY THE
STRUCTURAL BIGINEER. REFER TO CHAPTER 7 OF AG 318 FOR OTHER REINFORCING STEEL REQUIREMENTS.

MINIMUM LAPS AND EMBEDMENT

UNLESS OTHERWISE NOTED, REINFORCING SPLICE LENGTHS AND DEVELOPMENT LENGTHS SHALL BE AS TABULATED BELOW:

			fc=	2500 PSI		
	DEV	ELOPMENT	LENGTH		LAP	SPLICE
BAR	TENS	ION	COMPRESSION	TENS	ION	COMPRESSION
SIZE	TOP BARS	OTHER BARS	ALL BARS	TOP BARS	OTHER BARS	ALL BARS
#3	24	18	9	30	23	12
#4	31	24	12	41	31	15
#5	39	30	15	51	39	19
#6	47	36	18	61	47	23
#7	68	53	21	89	68	27
#8	78	60	24	102	78	30

			fc=	3000 PSI		
	DEV	ELOPMENT	LENGTH		LAP	SPLICE
BAR	TENS	ION	COMPRESSION	TENS	ION	COMPRESSION
SIZE	TOP BARS	OTHER BARS	ALL BARS	TOP BARS	OTHER BARS	ALL BARS
#3	22	17	9	28	22	12
#4	29	22	11	37	29	15
#5	36	28	14	47	36	19
#6	43	33	17	56	43	23
#7	63	48	20	81	63	27
#8	72	55	22	93	72	30

"TOP BARS" ARE HORIZONTAL REINFORCEMENT PLACED SUCH THAT MORE THAN 12 INCHES OF CONCRETE IS CAST IN THE MEMBER BELOW THE BAR.

CONCRETE COVER ON REINFORCING

CONCRETE CAST AGAINST AND PERMANENTLY EXPOSED TO EARTH:	3"
CONCRETE EXPOSED TO EARTH AND WEATHER:	
#G BARS AND LARGER	2"
#5 BARS AND SMALLER	1 1/2"

CONCRETE NOT EXPOSED TO EARTH OR WEATHER: SLABS, WALLS AND JOISTS COLUMN TIES OR SPIRALS AND BEAM STIRRUPS

CONCRETE GENERAL NOTES

VERTICAL BARS SHALL START FROM TOP OF FOOTING. HORIZONTAL BARS SHALL START A DISTANCE OF 1/2 THE NORMAL BAR SPACING FROM TOP OF FOOTING A NOT TOP OF FRAMED SLABS. IN ADDITION, THERE SHALL BE A HORIZONTAL BAR ATA MAXIMUM OF 3" FROM TOP OF WALL AND BOTTOM OF FRAMED SLARS.

PROVIDE CORNER BARS TO MATCH THE HORIZONTAL REINFORCING WITH TENSION LAP SPLICE AT EACH SIDE PER TABLE, OR BEND ONE SIDE OVER TO PROVIDE TENSION LAP.

PROVIDE CONTROL OR CONSTRUCTION JOINTS IN SLABS ON GRADE TO BREAK UP SLAB INTO RECTANGULAR AREAS OF NOT MORE THAN 400 SQUARE FEET EACH, AREAS TO BE AS SQUARE AS PRACTICAL AND HAVE NO ACUTE ANGLES, JOINT LOCATIONS TO BE APPROVED BY THE ARCHITECT.

ALL CONSTRUCTION JOINTS SHALL BE THOROUGHLY CLEANED AND PROPERLY PREPARED IMMEDIATELY PRIOR TO POURING OF CONCRETE, DOWEL STEEL SHALL BE THE SAME SIZE AND SPACING AS MAIN REINFORCING DETAILED BEYOND JOINT.

SEE ARCHITECTURAL DRAWINGS AND MECHANICAL DRAWINGS FOR EXACT LOCATIONS AND DIMENSIONS OF OPENINGS IN CONCRETE WAILS, FLOORS AND NOOF, UNICESS INDICATED OTHERWISE, REINFORCE ARQUING OPENINGS GEREATE HAM 22 I'S INTERFED REDICTION WITH 1/25 SECAL FORDE AND 1/25 SEA OF THE AND 1/25 SEA O

BARS PARTIALLY EMBEDDED IN HARDENED CONCRETE SHALL NOT BE FIELD BENT UNLESS SO DETAILED OR APPROVED BY THE STRUCTURAL ENGINEER.

SEE ARCHITECTURAL DRAWINGS FOR ALL GROOVES, NOTCHES, CHAMFERS, FEATURE STRIPS, COLOR, TEXTURE AND OTHER FINISH DETAILS AT ALL EXPOSED CONCRETE SURFACES. PROVIDE 3/4" CHAMFER AT

STRUCTURAL STEEL

STRUCTURAL STEEL DESIGN, FABRICATION AND ERECTION SHALL BE IN ACCORDANCE WITH THE AISC "SPECIFICATION FOR THE DESIGN, FABRICATION, AND ERECTION OF STRUCTURAL STEEL FOR BUILDINGS", LATEST EDITION.

ABOVE

ANCHOR BOL

ALTERMATE

ARCHITECT

BAR DIAMETI

BELOW

BLOCKING

BEAM

BEARING

BETWEEN

CLEAR

CONCRETE

CONNECTION

CONTINUOUS

DOLLBIE

DETAIL

DIAMETER

DIRECTION

EACH

ELEVATION

EACH SIDE

EXISTING

FLOOR

FAR SIDE

FOUNDATION

GENERAL CONTRACTO

COMPLETE JOINT PENETRATION

CONCRETE MASONRY UNIT

BTWN

CMU

CONN

COORD

SHAPES SHALL CONFORM TO ASTM A992 Ev = 50 KSL

STRUCTURAL TUBING SHALL CONFORM TO ASTM ASON GRADE R. FV = 46 KSI

STEEL PIPE SHALL CONFORM TO ASTM ASS GRADE B. Fy = 35 KSI.

BOLTS CONNECTING STEEL MEMBERS SHALL CONFORM TO ASTM A325-N. BOLTS SHALL BE 3/4°Ø MINIMUM, UNO ANCHOR BOLTS SHALL CONFORM TO ASTM A307.

CONTRACTOR SHALL PROVIDE CONNECTION ADJUSTMENT TOLERANCES TO SATISFY THE REQUIREMENTS OF AISC MANUAL OF STEEL CONSTRUCTION.

UNLESS SPECIFIED AS STAINLESS STEEL, ALL STEEL MEMBERS, SHAPES, BOLTS, AND ACCESSORIES EXPOSED TO WEATHER SHALL BE HOT DIP GALVANIZED.

WELDING

WELDING SHALL CONFORM TO AWS "STRUCTURAL WELDING CODE", LATEST EDITION. ALL WELDING SHALL BE DONE WITH 70 KSI LOW HYDROGEN ELECTRODES. WHERE NOT CALLED OUT, MINIMUM FILLET WELD SIZE SHALL BE PER TABLE 5.8 IN AWS 0.1.1, LATEST EDITION.

WELDING OF REINFORCING BARS SHALL NOT BE PERMITTED UNLESS SPECIFICALLY CALLED OUT ON DAWNINGS OR APPROVED BY STRUCTURAL ENGINEER. WELDING OF GRADE OR REINFORCING BARS PERFORMED USING ION WYDROGOED HECKTRODES. WELDING OF GRADE OR HORNOCING BARS PERFORMED USING STOKE LECTRODES. SEE SEINFORCING NOTES FOR MATERIAL REQUIREMENTS. WELDED BARS, WELDING WITH WITH OF THE WELD BARS, WELDING WITH OF THE WELDING WITH OF THE WELDING WITH OF THE WELDING WELDING

ALL WELDING SHALL BE DONE BY WASHINGTON ASSOCIATION OF BUILDING OFFICIALS (WABO) CERTIFIED WELDERS.

EXISTING BUILDING

CONTRACTOR SHALL VERIFY ALL DIMENSIONS, MEMBER SIZES AND CONDITIONS OF THE EXISTING BUILDING DEPICTED IN THE DRAWINGS, AND NOTIFY THE STRUCTURAL ENGINEER OF ANY DISCREPANCIES FOR

CONTRACTOR RESPONSIBLE FOR COMPLETELY SEALING ALL AREAS WHERE EXISTING ROOF MATERIAL IS PRINFRATED OR REMOVED. PROVIDE WATER PROOFING AS REQUIRED BY THE ARCH.

STRUCTURAL DRAWINGS SHALL BE USED IN COMUNCTION WITH ARCHITECTURAL, CIVIL, ELECTRICAL, AND MECHANICAL DRAWINGS FOR BIODING AND CONSTRUCTION. CONTINACTOR SHALL VERY PLAL DIMENSIONS AND COMPATIBILITY BEFORE PROCEEDING, ANY DISCREPANCIES SHALL BE BROUGHT TO THE ATTENTION OF THE ARCHITECT BEFORE PROCEEDING.

CONTRACTOR TO SEE ARCHITECTURAL, CIVIL, ELECTRICAL AND MECHANICAL DRAWINGS FOR SIZE AND LOCATION OF PIPE, VENT, DUCT AND OTHER OPENINGS AND DETAILS NOT SHOWN ON THESE DRAWINGS.

CONTRACTOR SHALL BE RESPONSIBLE FOR ERECTION STABILITY AND TEMPORARY SHORING AS NECESSARY UNTIL PERMANENT SUPPORT AND STIFFENING ARE INSTALLED.

CONTRACTOR-INITIATED CHANGES SHALL BE SUBMITTED IN WRITING TO THE ARCHITECT AND STRUCTURAL ENGINEER FOR APPROVAL PRIOR TO FABRICATION OR CONSTRUCTION, CHANGES SHOWN ON SHOP DRAWINGS ONLY WILL NOT SATISFY THIS REQUIREMENT.

DRAWINGS INDICATE GENERAL AND TYPICAL DETAILS OF CONSTRUCTION, WHERE CONDITIONS ARE NOT SPECIFICALLY INDICATED BUT ARE OF A SIMILAR CHARACTER TO DETAILS SHOWN, SIMILAR DETAILS OF CONSTRUCTION SHALL BE USED, SUBJECT TO REVIEW AND APPROVAL BY THE ARCHITECT AND THE CONSTRUCTION SHALL BE USED, SUBJECT TO REVIEW AND APPROVAL BY THE ARCHITECT AND THE

8	
King Cou	nty

SUQUAMISH

(NEW BUILD)

22063 DEWBERRY RD NE INDIANOLA WA 96342



GLUE-LAMINATED BEAM

KIPS PER SOLIARE INCH

POUNDS PER SQUARE INCH

POUNDS PER SQUARE FOOT

POST TENSIONE

REINFORCING

SCHEDULE

SIMILAR

STIFFFNER

SYMMETRICAL

TOP OF CONCRETE TOP OF STEEL

UNLESS NOTED OTHERWISE

SHEARWALL

TYPICAL

WIDE FLANG

STEEL

SLAB ON GRADI

DDESCRIPE TREATED

MOMENT FRAM

HORIZONTAL

ANGLE

METAL

ON CENTER

OPPOSITE

PLATE

HORIZ

MTL

REINF

REQ'D

SCHED

SIM

STIFE

TOC

5505 6TH AVE. S. SUITE 202



ZOS

мтм

PREPARED BY APPROVED BY

REV DATE DESCRIPTION


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FOUNDATIONS STRUCTURAL NOTES

SHEET NUMBER

F1.1



22063 DEWBERRY ROAD NE

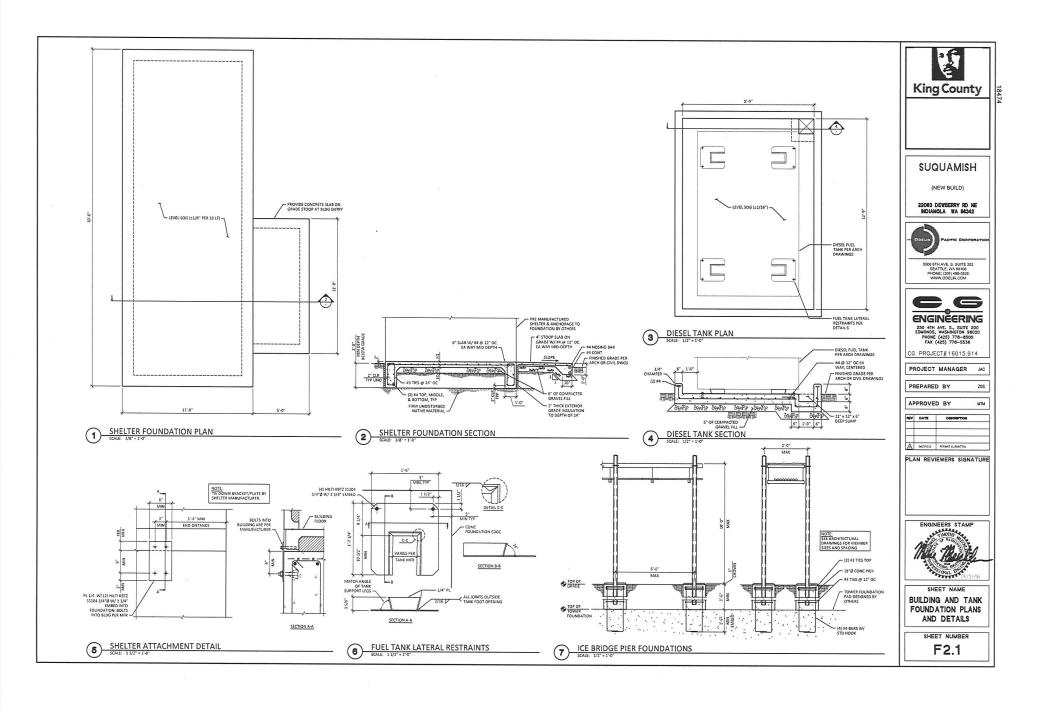

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PROJECT MANAGER

PREPARED BY

APPROVED BY:

TAV

PLAN REVIEWERS SIGNATURE

SHEET NAME MECHANICAL 8-17-17 PLAN

VEACH Consulting Engineers

12202 Pacific Ave. S Suite B Tacoma, WA 98444 Ph: 253-274-5701 Projil 1532

SHEET NUMBER M1.0



LEAK DETECTION


PROVIDE LEAK MONITORING OF THE DOUBLE-WALLED FUEL PIPING, AND THE DOUBLE-WALLED FUEL TANK.

PROVIDE LIQUID DETECTOR IN DOUBLE WALLED FUEL TANK.

PROVIDE DETECTOR FOR DOUBLE WALLED FLEXIBLE FUEL PIPING.


PROVIDE A LIQUID DETECTOR IN THE DOUBLE WALLED DAY TANK.


PROVIDE CONDUIT AND WIRE FROM PANEL TO EACH LEAK DETECTION DEVICE.

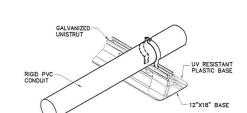

PIPE SUPPORT

NOT TO SCALE

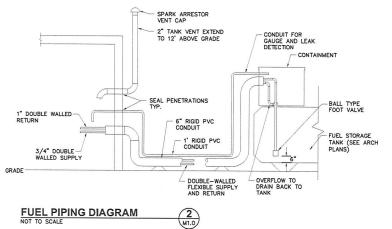

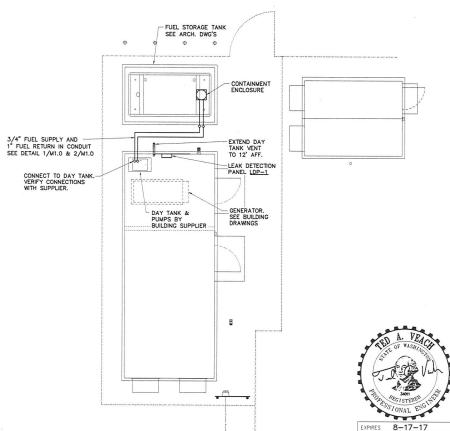

DRAWING NOTES:


1. FUEL PIPING INSTALLATION SHALL CONFORM TO 2015 NFPA 30.


CONTRACTOR SHALL LAY OUT CONTAINMENT CONDUITS AND PIPING SO THAT ANY POINT OF LEAKAGE IS CAUGHT BY SECONDARY CONTAINMENT AND ALARMS WITH THE LEAK DETECTION SYSTEM.


COORDINATE CONNECTION OF LEAK DETECTION SYSTEM TO REMOTE MONITORING.

2. SEAL ALL CONDUIT AND CONTAINMENTS TO BE WATER TIGHT.

FUEL SYSTEM - SITE PLAN SCALE: 1/4" = 1' - 0"

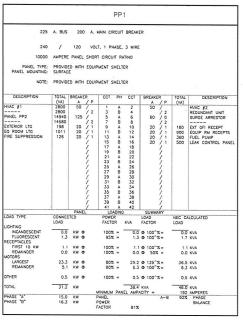

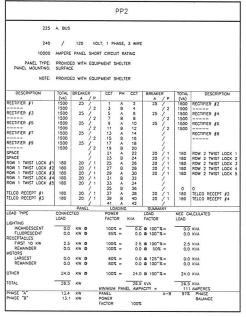

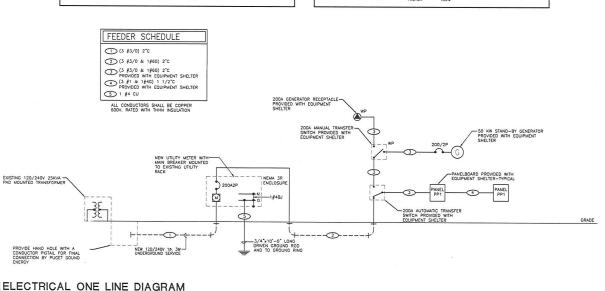

INSTALLATION OF SECONDARY POWER AND CONNECTION TO METER SHALL BE COMPLETED IN COMPLIANCE WITH NATIONAL ELECTRIC COOPE, PIPPA 70, AND THE STATE OF WISHINGTON LAWS, RULES AND REGULATIONS FOR INSTALLING ELECTRIC WIRES & EQUIPMENT, ALL LATEST ISSUE, AND WITH SPECIFICATIONS FOR AST,M. B 231, B 400, LCEA, S651-401, LCEA, P651-4701, &LCEA, P611-4701, &LCEA, P

PROVIDE A METER BASE PER LOCAL UTILITY STANDARDS. MOUNT ON EXISTING UTILITY RACK PER PLAN. SEE PAGE E-2

3. UNDERGROUND CONDUTT SHALL BE FIRED POLYMENT, CHARGES CONDUTT, SHADULE 40. THE 1, CONFIDENCE TO IL ARTICLE SIX IN SECTION PLANTS OF CREATED AND ANALYSET OF THE SOLVENT, WESTERN THE COMPATIBLE WITH POR DUST, ALL BEINDS SHALL BE TWO SWEPT THE WITH A 24" MINIMUM RADIUS, ALL CONDUIT UNDER ROADS SHALL BE ROS, (OR PVC DECASED) IN STAIR "BOX DIONESCET DUSTRIANS."

CONDUIT USED INDOORS SHALL BE EM.T., AND RIGID GALVANIZED STEEL FOR OUTDOORS.
COUPLINGS SHALL BE RIGID STEEL AND COMPRESSION TYPE FOR EM.T. SET SCREW
FITTINGS ARE NOT PERMITTED. FOR ALL STUBS-UPS, USE RIGID GALVANIZED STEEL
COMDUIT.

WIRE AND CABLE SHALL BE OF THE TYPE AND SIZE AS REQUIRED BY NEC. THERE WILL BE NO SPLICES ALLOWED.
PROVIDE HOPE PULLING HAND HOLES AS NEEDED.

CONTRACTOR SHALL PROVIDE TEST OF THE GROUNDING SYSTEM BY CERTIFIED TESTING ARBITIST, PROVIDE NEEDED THE STEED TO THE PROJECT MANAGER FOR REVIEW. ARBITIST, PROVIDE NEEDED THE STRUCK ARBITIST, PROVIDENT STANDARD ARBITIST, CARE SHALL BE COMPACT AND FOR THE STRUCK ARBITIST, STANDARD ARBIT

ALL EXTERIOR GROUND BARS SHALL BE COATED WITH ANTI-CORROSIVE AGENT SUCH AS LPS-3 OR AS PER NOTE 6 ABOVE.

ALL JUNCTION AND OUTLET BOXES TO BE LABELED WITH KROY TAPE, OR EQUAL DESIGNATING ALL CIRCUIT NUMBERS CONTAINED IN EACH BOX.

9. CONTRACTOR TO ENSURE ILC PROVIDED WITH (2) INTERNAL TVSS.

CONTRACTOR SHALL COORDINATE WITH SITE SURVEY TO LOCATE EXISTING UNDERGROUND UTILITIES. WHEREVER POTENTIAL CONFLICTS/ INTERFERENCES EXIST, MAND EXCAVATE TO AVOID DAMAGE. CONTACT ALL UTILITIES TO LOCATE UNDERGROUND PIPING IN PUBLIC ROW.

11. VERIFY THAT A.L.C. OF THE UTILITY DOES NOT EXCEED THE A.L.C. RATING OF THE PROVIDED EQUIPMENT SHELTER PACKAGE. IF OVER TOKAK, PROVIDE FUSIBLE SERVICE ENTRANCE SWITCH AND CONFIRM LOWERING OF AIC TO ACCEPTABLE LEVELS.

12. UTILITY POINTS OF SERVICE AND WORK / MATERIALS SHOWN ARE BASED UPON PRELIMINARY INFORMATION PROVIDED BY THE UTILITY COMPANIES AND ARE FOR BID PURPOSES ONLY.

13. COMPRICTOR SHALL COORDINATE WITH LITLIN' COLUMNY FOR FINAL AND EXECT WORK. AMATERIALS REQUESTED TO CONSTRUCT TO LITLIN' COMPANY FOR SOMECTION, TOWARD AND SPECIFICATIONS ONLY. CONTRACTOR SHALL FRENCH AND INSTALL ALL CONDUIT. PULL ROPES, CAUBLES, PLUE DOSES, CONCRETE EXASSIGNT OF CONDUIT (OF ROQUINES). TRANSFORMER PAD, BARRIERS, POLE RISERS, TRENCHING, BACKFILL, PAY ALL UTILITY COMPANY FEES AND INCLUDE ALL REQUISIDENTS IN SCOPE OF WORK.

GENERAL NOTES

ABBREVIATIONS INTERMEDIATE METALLIC CONDUIT BARE COPPER WIRE MCR MASTER GROUND BAR PCS PERSONAL COMMUNICATION ELECTRICAL METALLIC TUBING RGS RIGID GALVANIZED STEEL GENERATOR INTERIOR GROUND RING (HALO) RWY RACEWAY

-- UE- - UNDERGROUND RACEWAY -- GROUND CONDUCTOR PANELBOARD FUSED DISCONNECT FEEDER KEY LOCAL DISCONNECT GROUND GROUND ROD PANELBOARD EXOTHERMIC WELD COMPRESSION TYPE
CONNECTION M METER TEST WELL AUTOMATIC TRANSFER SWITCH

G STAND-BY GENERATOR

LEGEND / ABBREVIATIONS

ELECTRICAL SERVICE WEATHERHEAD

King County

PSERN RADIO NETWORK

SUQUAMISH

(NEW BUILD)

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LM

PN

PROJECT MANAGER: EJC

PREPARED BY

APPROVED BY-

08/23/16 ISSUED FOR PERMIT 06/23/16 ISSUED FOR REVIEW 05/26/16 ISSUED FOR REVIEW

05/24/16 ISSUED FOR REVIEW PLAN REVIEWERS SIGNATURE

MREMETERSTPERFAME 1 ARCHITECT


WAUL NIXON STATE OF WASHINGTON

> **ELECTRICAL** ONE LINE DIAGRAM

SHEET NUMBER

E-1

E-2

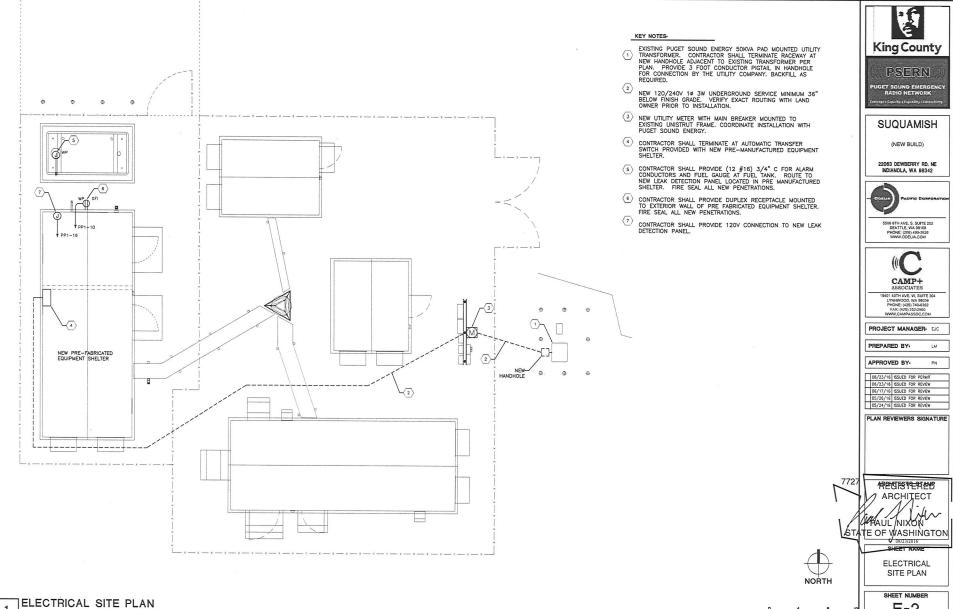

SCALE 1/4" - 1'-0" (22x34) 1/8" - 1'-0" (11x17)



PSERN

SUQUAMISH

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PROJECT MANAGER: EJC

PREPARED BY

08/23/16	ICCLIED	FOD	DEDUC
06/23/16			
06/17/16			
05/26/15	ISSUED	FOR	REVIEW
05/24/16	ISSUED	FOR	REVIEW

PLAN REVIEWERS SIGNATURE

MENTE TET END 1 ARCHITECT

CAPAUL NIXON STATE OF WASHINGTON

GROUNDING PLAN & NOTES

SHEET NUMBER

E-3

GENERAL NOTES

ALL ELECTRICAL CADWELD AND MECHANICAL GROUND CONNECTIONS WILL HAVE NON-OXIDATION COMPOUND APPLIED TO CONNECTION.

ANY METAL OBJECTS WITHIN 6 FEET OF THE EXTERNAL GROUND RING SHALL BE GROUNDED.

CONNECTIONS TO THE GROUND BUS SHALL NOT BE DOUBLED UP OR STACKED. BACK TO BACK CONNECTIONS ON OPPOSITE SIDES OF THE GROUND BUS ARE PERMITTED.

8. OBSERVE NEC AND LOCAL UTILITY REQUIREMENTS FOR ELECTRICAL SERVICE GROUNDING.

9. MAXIMUM RESISTANCE OF THE COMPLETED GROUND SYSTEM SHALL NOT EXCEED 5 OHMS.

10. SITE TO COMPLY WITH R56 STANDARDS FOR GROUNDING

	LEGEND
ITEM	DESCRIPTION
8	3/4" DIAMETER x 10'-0" LONG COPPER CLAD GROUND ROD, MINIMUM 30" BELOW GRADE, AT MINIMUM 10'-0" O.C. (HARGER #5810).
⊠	CADWELD INSPECTION WELL (SEE DETAIL 3/E-2).
-	\$2 AWG TINNED SOLID BARE COPPER WIRE, MINIMUM 30" BELOW GRADE, OR 6" BELOW LOCAL FROST LINE.
	CADWELD/EXOTHERMIC WELD CONNECTION.
- 0 -	HECHANICAL CONNECTION

KEYED NOTES

- (E) 400' HIGH GUYED TOWER
- 2 NEW 11'-8" X 30'-0" EQUIPMENT SHELTER.

- 5 NEW MASTER GROUND BAR MOUNTED AT BASE OF TOWER. PROVIDE (2) \$2 BARE SOLID TINNED COPPER CONDUCTORS TO EXOTHERMIC WELD CONNECTION AT NEW EXTERIOR GROUND RING.

- (5) NEW EXTERNAL GROUND BAR MOUNTED BELOW ENTRY PANEL PROVIDE (2) #2 BARE SOLID TINNED COPPER CONDUCTOR TO EXOTHERMIC WELD CONNECTION AT NEW SHELTER GROUND RING.
 - (14) PIPE BOLLARD GROUNDING, #2 BARE SOLID TINNED COPPER CONDUCTOR FROM EXOTHERMIC WELD CONNECTION AT EXISTING GROUND RING TO EXOTHERMIC WELD CONNECTION AT PIPE BOLLARD, TYP.

SITE GROUNDING PLAN SCALE: 3/8" - 1'-0" (22x34), 3/16" - 1'-0" (11x17)


-x-

INTERNAL HALO GROUND SYSTEM PROVIDED BY SHELTER MANUFACTURER

TN Z

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(15)-

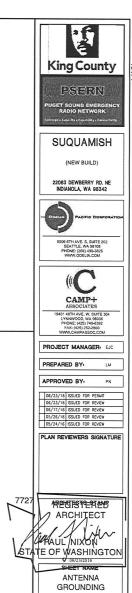


SHEET NUMBER

E-4

ANTENNA PLAN @ 120'-0"

SCALE: 1/4" - "-0" (22x34), 1/8" - "-0" (11x17)

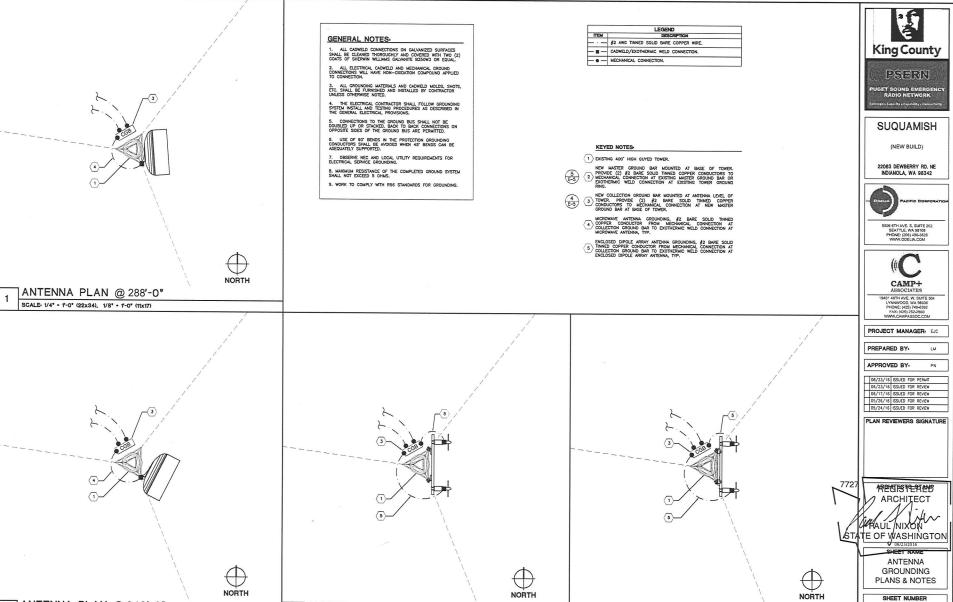

ANTENNA PLAN @140'-0"

SCALE: 1/4" - 1-0" (22x34), 1/8" - 1-0" (11x17)

ANTENNA PLAN @ 240'-0"

SCALE: 1/4" - 1'-0" (22x34), 1/8" - 1'-0" (11x17)

